




THRUST BLOCK AT PLUG OR HYDRANT SHOE

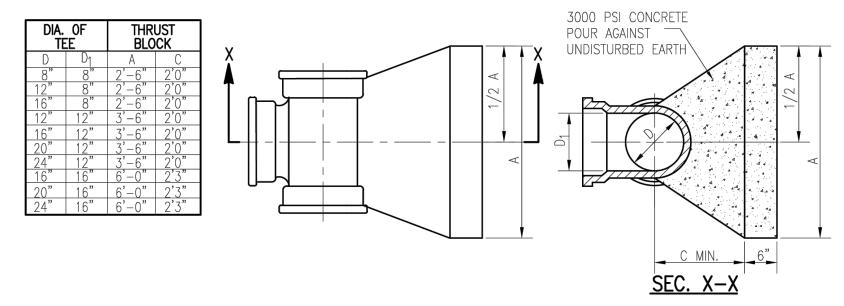

#### THRUST BLOCK AT TAPPING SLEEVE TEE NOT TO SCALE

CONCRETE THRUST BLOCKS WILL NOT BE PERMITTED EXCEPT BEHIND HYDRANT SHOES AND TAPPING SLEEVES. USE OF CONCRETE THRUST BLOCKS IN OTHER LOCATIONS WILL NOT BE PERMITTED WITHOUT THE WRITTEN APPROVAL OF YCUA. ALL OTHER VERTICAL AND HORIZONTAL BENDS SHALL BE RESTRAINED WITH FIELD-LOK GASKETS OR APPROVED MECHANICAL JOINTS.

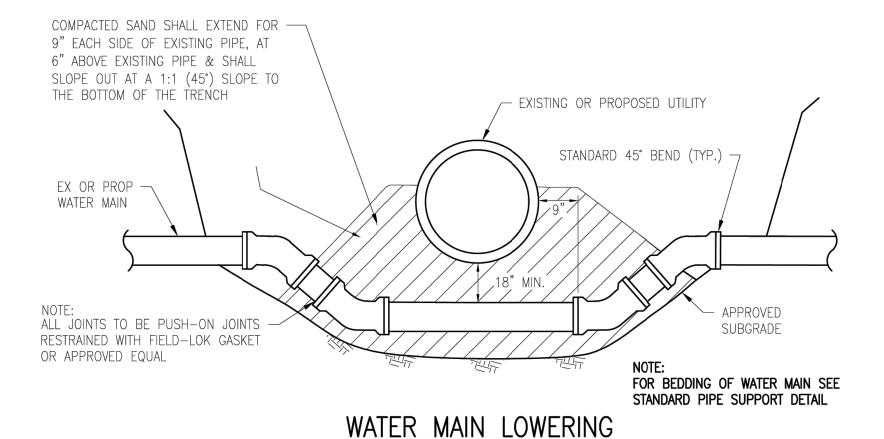

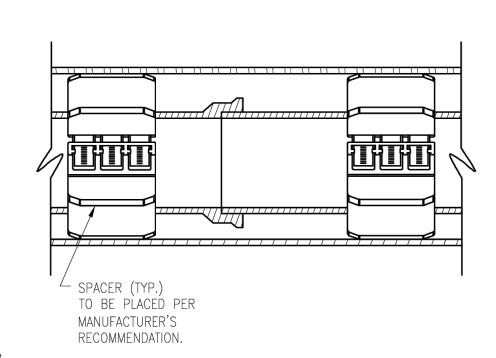


NOT TO SCALE

SPACER END VIEW NOT TO SCALE

### STANDARD CASING SECTION NOT TO SCALE

1. SPACERS FOR PLACEMENT IN THE ANNULAR SPACE BETWEEN THE CARRIER PIPE AND A CASING PIPE SHALL BE RANGER II AS MANUFACTURED BY PSI OR APPROVED EQUAL.


2. END SEALS SHALL BE MODEL C RUBBER SEAL WITH STAINLESS STEEL BANDS AS MANUFACTURED BY PSI OR APPROVED EQUAL.

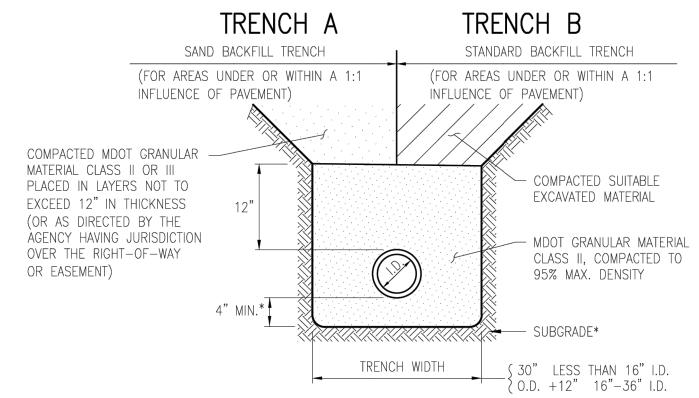


## BEDDING AND TRENCH BACKFILL DETAIL FOR WATER MAIN

NOT TO SCALE

NOTE: IF THE EXISTING SUBGRADE MATERIAL MEETS THE REQUIREMENTS FOR MDOT GRANULAR MATERIAL CLASS II (MINIMUM 4" THICK), THEN THE WATER MAIN MAY BE LAID DIRECTLY ON THE COMPACTED EXISTING SUBGRADE MATERIAL.

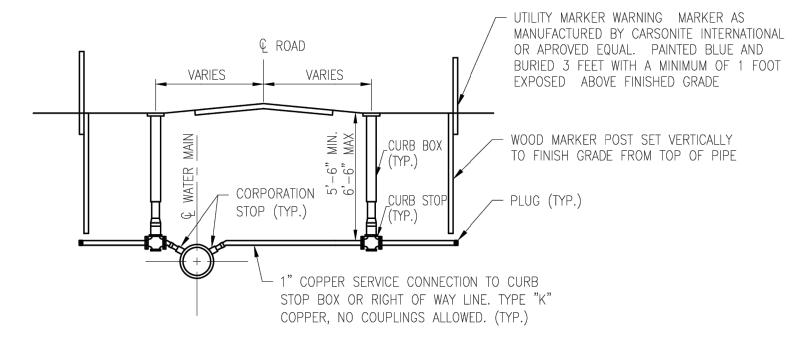

#### TYPICAL WATER SERVICE NOT TO SCALE

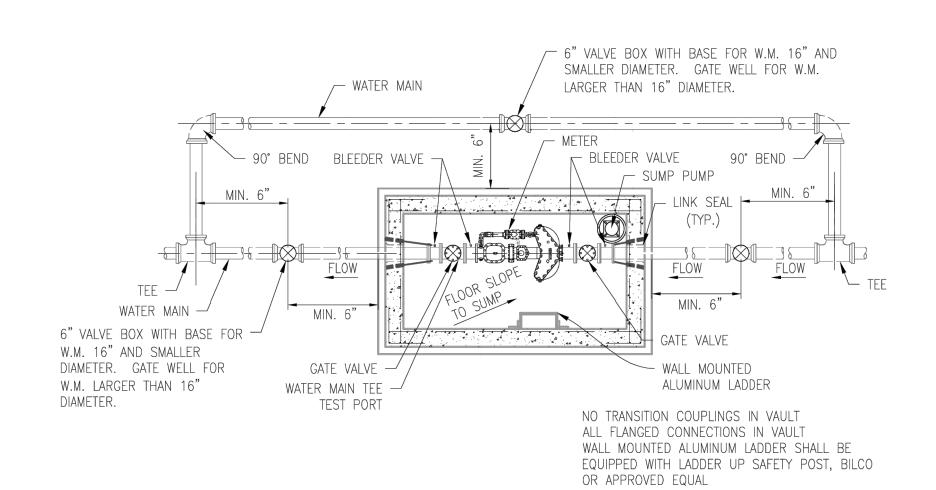

# MASTER METER VAULT **CONFIGURATION (WITHOUT COVER)**

NOT TO SCALE

1. WHERE POSSIBLE THE METER VAULT SHALL BE LOCATED AWAY FROM TRAFFIC AREAS, ROADS, PARKING LOTS, ETC. 2. THE ACCESS HATCH SHALL BE SIZED LARGE ENOUGH TO ACCOMMODATE REMOVAL OF THE LARGEST METER OR THE LARGEST APPURTENANCE FOR MAINTENANCE PURPOSES. THE HATCH SHALL BE MANUFACTURED BY THE BILCO COMPANY. METER VAULT HATCH SHALL BE WATER TIGHT.

3. THE METER VAULT FLOOR SHALL BE SLOPED TO THE SUMP.

4. ELECTRICAL SERVICE SHALL BE SUPPLIED TO THE VAULT.



DATE

10/06/2023

03/27/2024

05/24/2024

06/13/2024

REVISION


SITE PLAN

REVISED SITE PLAN REVISED SITE PLAN PER TOWNSHIP COMMENTS

REVISED PER FIRE COMMENTS

**REVISED SITE PLAN PER TOWNSHIP COMMENTS** 

06/25/2024 REVISED PER WASHTENAW COUNTY WATER RESOURCES COMMENTS CJW

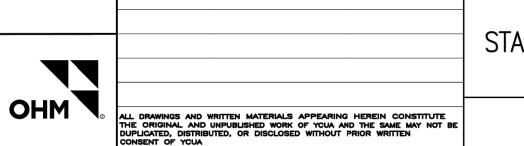

CJW

## YPSILANTI COMMUNITY UTILITIES AUTHORITY 2777 STATE ROAD STANDARD WATER MAIN DETAILS YPSILANTI, MICHIGAN 48198-9112 ALL DRAWINGS AND WRITTEN MATERIALS APPEARING HEREIN CONSTITUTE THE ORIGINAL AND UNPUBLISHED WORK OF YCUA AND THE SAME MAY NOT B DUPLICATED, DISTRIBUTED, OR DISCLOSED WITHOUT PRIOR WRITTEN CONSENT OF YCUA 09/25/19 NO SCALE






1139 Byron Center, M Vriesman (616) 277-2185 CHECKED (269) 697-7120 Sheet No. C504


(734) 484-4600

WWW.YCUA.ORG


FAX: (734) 544-7221

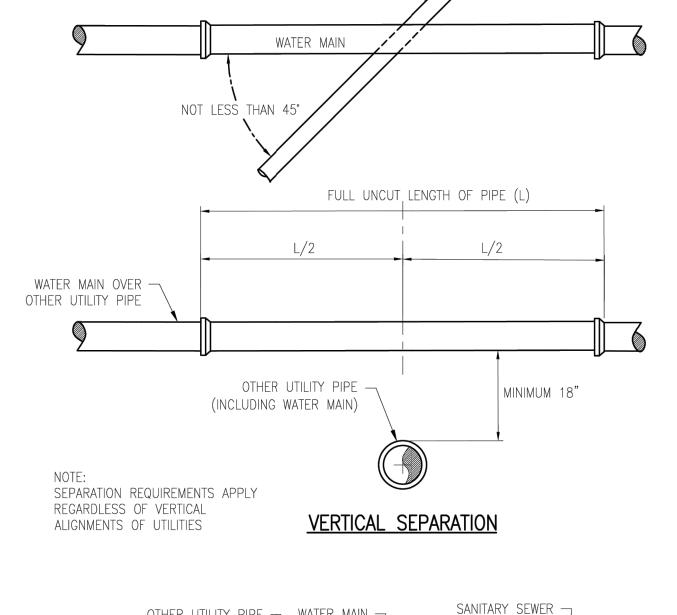

OTHER UTILITY PIPE -(INCLUDING WATER MAIN)

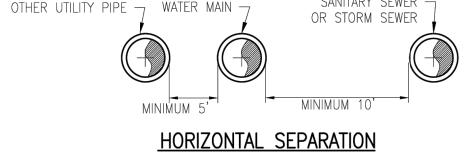


### WATER MAIN CROSSING OTHER UTILITIES NOT TO SCALE

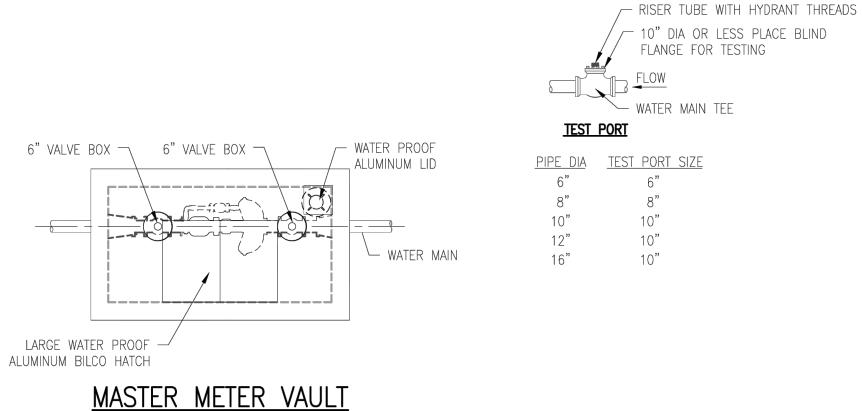


NOT TO SCALE

CONFIGURATION WITH COVER

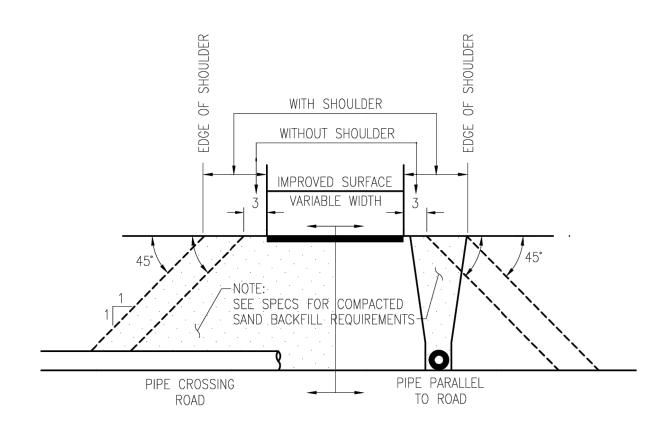


# BACKFILL IN THE AREA OF STREETS, ALLEYS SIDEWALKS, DRIVES & PARKING LOTS

NOT TO SCALE

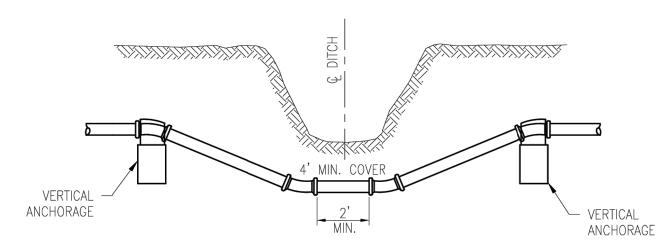

USE FIELD-LOK GASKETS AT ALL NECESSARY NON-MECHANICAL JOINTS PER APPROVED RESTRAINING SCHEDULE


#### STANDARD DITCH CROSSING NOT TO SCALE

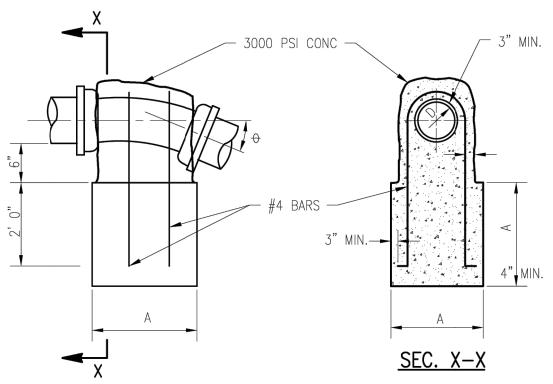


DETAIL OF VERTICAL ANCHORAGE NOT TO SCALE

DIA. OF WATER MAIN	BEND	Α	NUMBER OF BARS
D	0		
6"	22 1/2° 45°	2'-0" 3'-3"	2
8"	22 1/2° 45°	3'-3" 4'-0"	2
12"	11 1/4° 22 1/2°	3'-3" 4'-0"	2 3
16"	11 1/4° 22 1/2°	3'-3" 4'-0"	2
20"	11 1/4° 22 1/2°	4'-0" 5'-0"	2
24"	11 1/4° 22 1/2°	4'-0" 5'-0"	2


#### WHERE CONCRETE ENCASEMENT IS SPECIFIED FOR NEW UTILITY A 6" MINIMUM LAYER OF MECHANICALLY COMPACTED SAND SHALL BE MAINTAINED BETWEEN EX. UTILITY & TOP OF

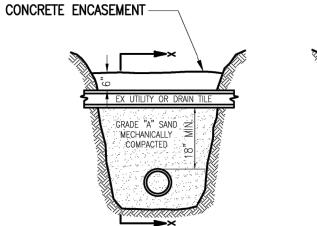


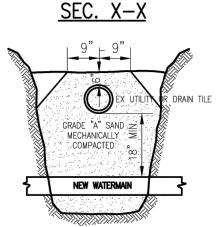

COMPACTED SAND SHALL EXTEND FOR 9" EACH SIDE OF EXISTING PIPE, AT 6" ABOVE EXISTING PIPE & SHALL SLOPE OUT AT A 1:1 (45°) SLOPE TO THE BOTTOM OF THE TRENCH

## STANDARD PIPE SUPPORT NOT TO SCALE

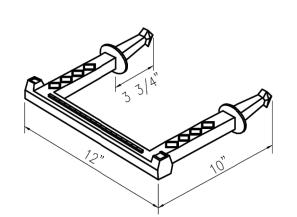


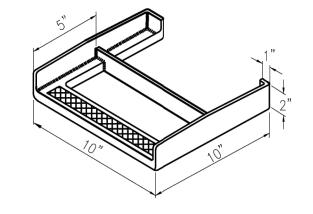

MANHOLE STEP M.A. PSI-375 USE AS REQUIRED

STANDARD MANHOLE STEP EJ 8500 USE AS REQUIRED

INSTALLED IN ECCENTRIC WELLS ONLY. CONCENTRIC WELLS WILL NOT BE INSTALLED WITH STEPS.

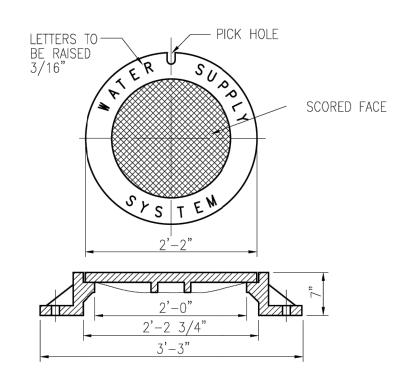

STANDARD FRAME & COVER EJ #1040 USE AS "REQUIRED

### PIPE RESTRAINT SCHEDULE

THE FOLLOWING TABLE IS A JOINT RESTRAINT SCHEDULE (DIPRA) FOR GROUND-BURIED DUCTILE IRON OR PVC PIPE. LENGTHS OF PIPE RESTRAINT ARE GIVEN IN FEET.


PIPE DIAMETER	TEES, 90°, PLUGS	45° BENDS	22 ½° BENDS	REDUCERS
6"	40	25	25	30
8"	55	25	25	30
12"	80	35	25	55
16"	100	40	25	60
24"	135	56	25	65

BASED UPON

INTERNAL PRESSURE: PIPE DEPTH: BEDDING CLASS: TYPE 4 SOIL TYPE: GOOD SAND SAFETY FACTOR:

- 1. IF PIPE DIAMETER IS NOT LISTED IN THIS TABLE; THE NEXT LARGEST PIPE SHALL BE USED. THIS TABLE IS BASED ON A TEST PRESSURE OF 180 PSI (OPERATING PRESSURE PLUS WATER HAMMER).
- 2. FOR OTHER TEST PRESSURES, ALL VALUES TO BE INCREASED OR DECREASED PROPORTIONALLY. THE VALUES PROVIDED OF RESTRAINT LENGTH ARE IN EACH DIRECTION FROM THE POINT OF DEFLECTION OR TERMINATION EXCEPT FOR TEES, AT WHICH ONLY THE BRANCH IN THE DIRECTION OF THE STEM.
- 3. IF TIE RODS ARE USED, USE FOUR RODS MINIMUM AND ADD 1/8 INCH TO BAR DIAMETER AS CORROSION ALLOWANCE. SIZE REDUCTION IS BASED UPON THE PIPE DIAMETER SHOWN IN THIS TABLE.
- 4. MANUFACTURER'S RESTRAINT SCHEDULE AND SPECIFIC SITE CONDITIONS MAY MODIFY THE ABOVE SCHEDULE. ANY ALTERNATIVE SCHEDULE SHALL BE SUBMITTED TO YOUA FOR APPROVAL.


# TRACER WIRE DETAILS

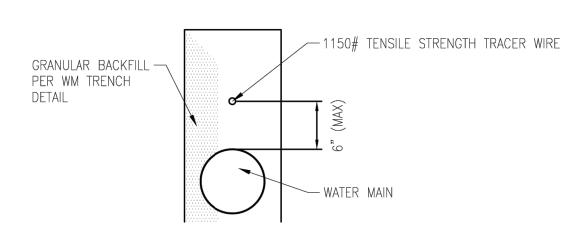





OPEN CUT MAIN LINE TRENCH


NOT TO SCALE

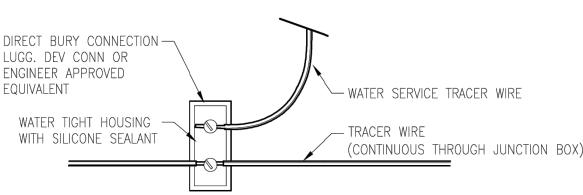


CURB BOX WIRE COIL NOT TO SCALE

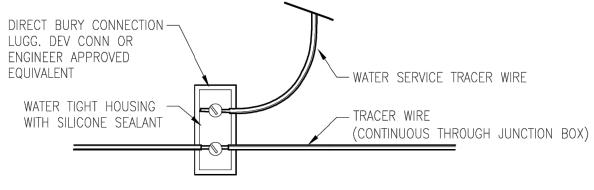

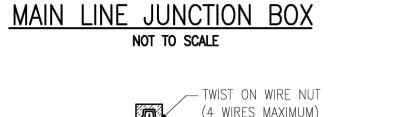


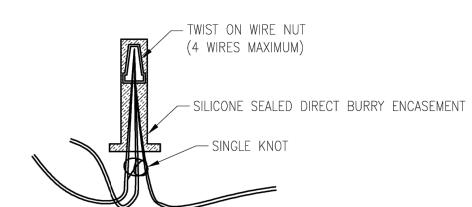


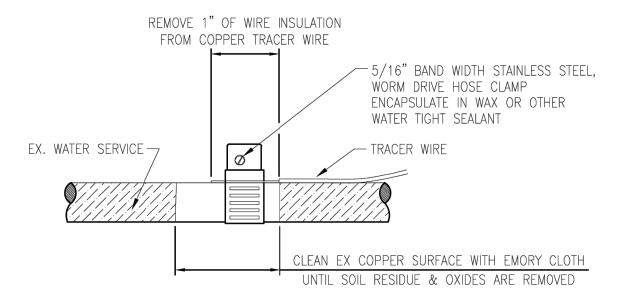


WATER SERVICE TERMINATION NOT TO SCALE

## SPLICE CONNECTOR NOT TO SCALE

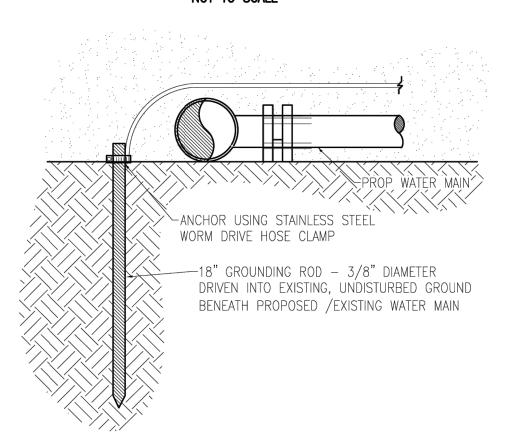

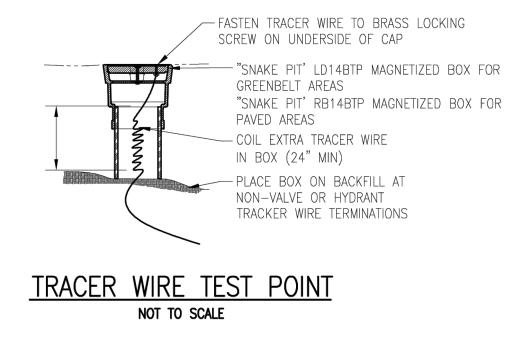

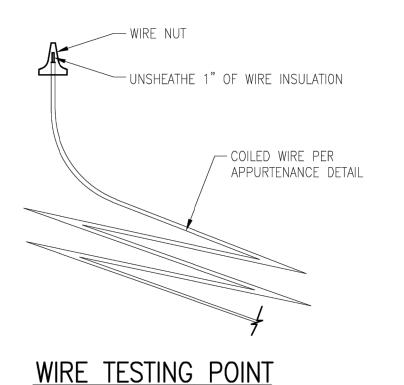


NOT TO SCALE

**GROUNDING ROD TERMINATION** NOT TO SCALE

--- WIRE TESTING POINT CONNECT TRACER WIRE TO ----- CABLE TIE EX WATER SERVICE WITH PIPE CLAMPS SEE WATER SERVICE TRACER - MAIN LINE JUNCTION BOX WIRE TERMINATION DETAIL





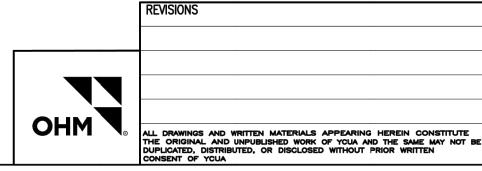

STANDARD WATER MAIN DETAILS

YPSILANTI COMMUNITY UTILITIES AUTHORITY 2777 STATE ROAD YPSILANTI, MICHIGAN 48198-9112 FAX: (734) 544-7221 ENVIRONMENTAL LEADERS WWW.YCUA.ORG NO SCALE 09/25/19

REVISION DATE 10/06/2023 SITE PLAN 03/27/2024 REVISED SITE PLAN REVISED SITE PLAN PER TOWNSHIP COMMENTS 05/24/2024 CJW 06/13/2024 REVISED PER FIRE COMMENTS 06/25/2024 REVISED PER WASHTENAW COUNTY WATER RESOURCES COMMENTS CJW **REVISED SITE PLAN PER TOWNSHIP COMMENTS** 


YPSILANTI TOWNSHIP WASHTENAW COUNTY, MICHIGAN


YPSILANTI HOLIDAY INN EXPRESS


PROJECT DETAILS

& Korhorn Kalamazoo, MI www.VKcivil.com

1139 Byron Center, M Vriesman (616) 277-2185 CHECKED (269) 697-7120 Sheet No. C505

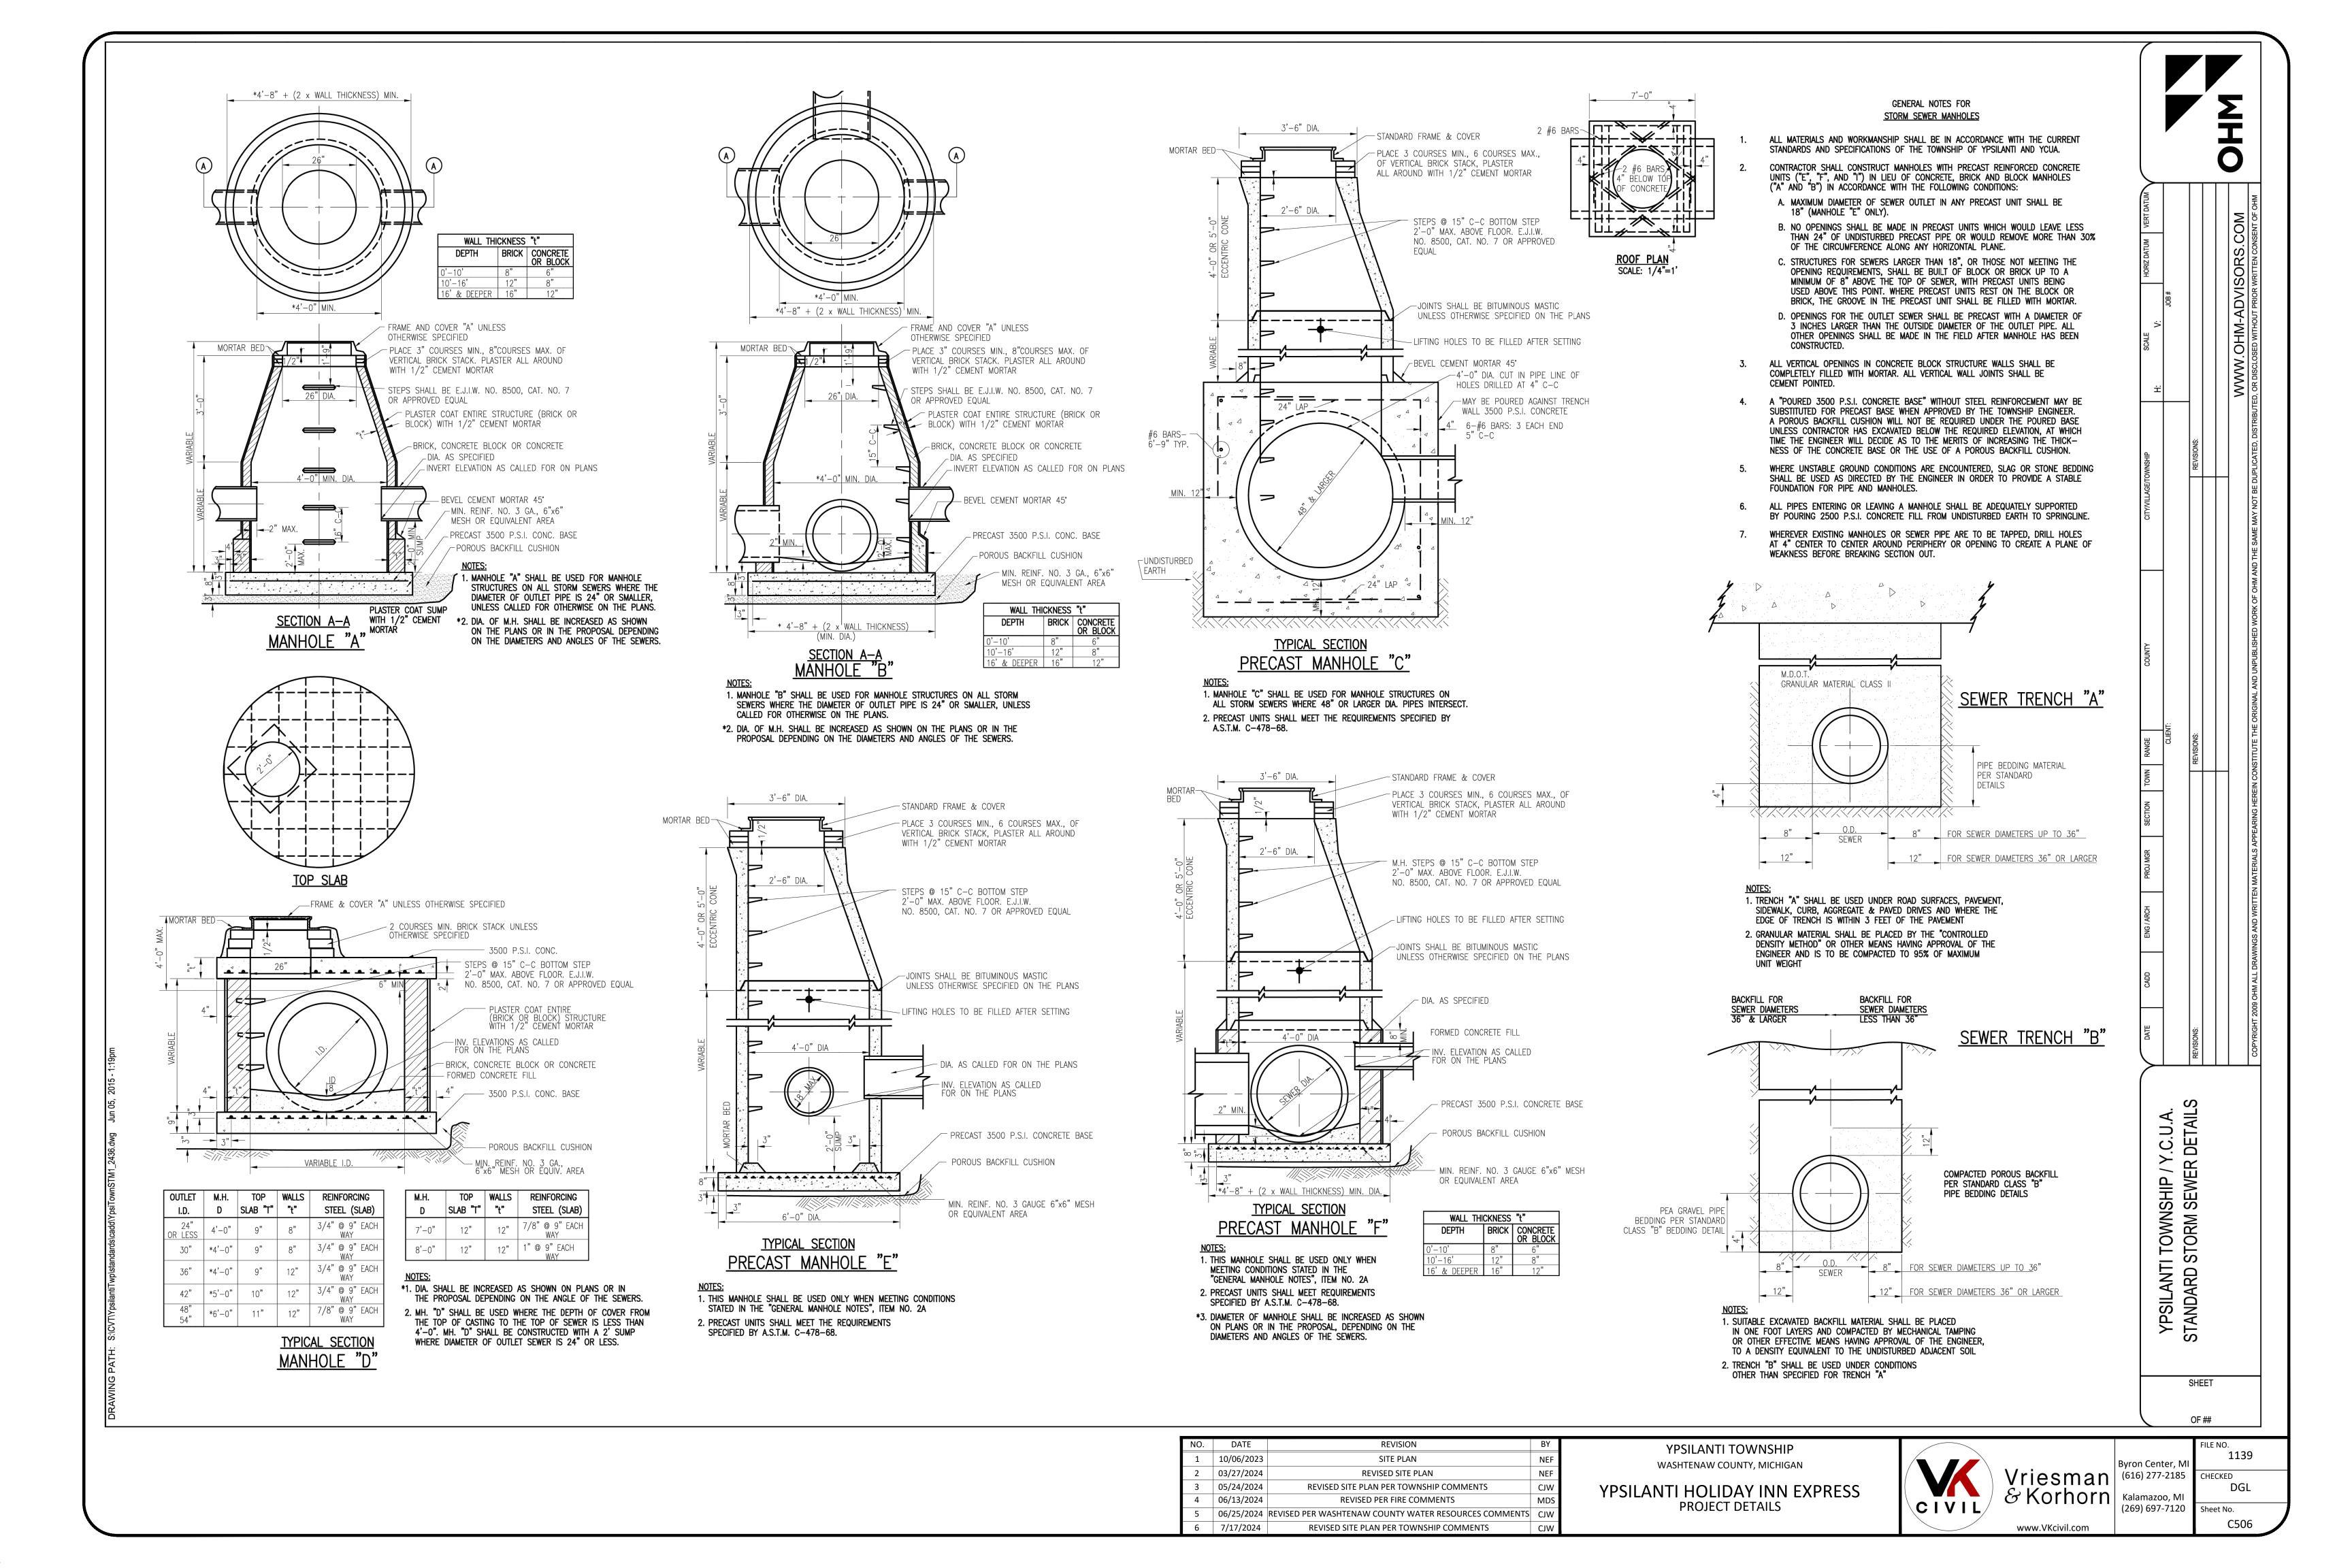

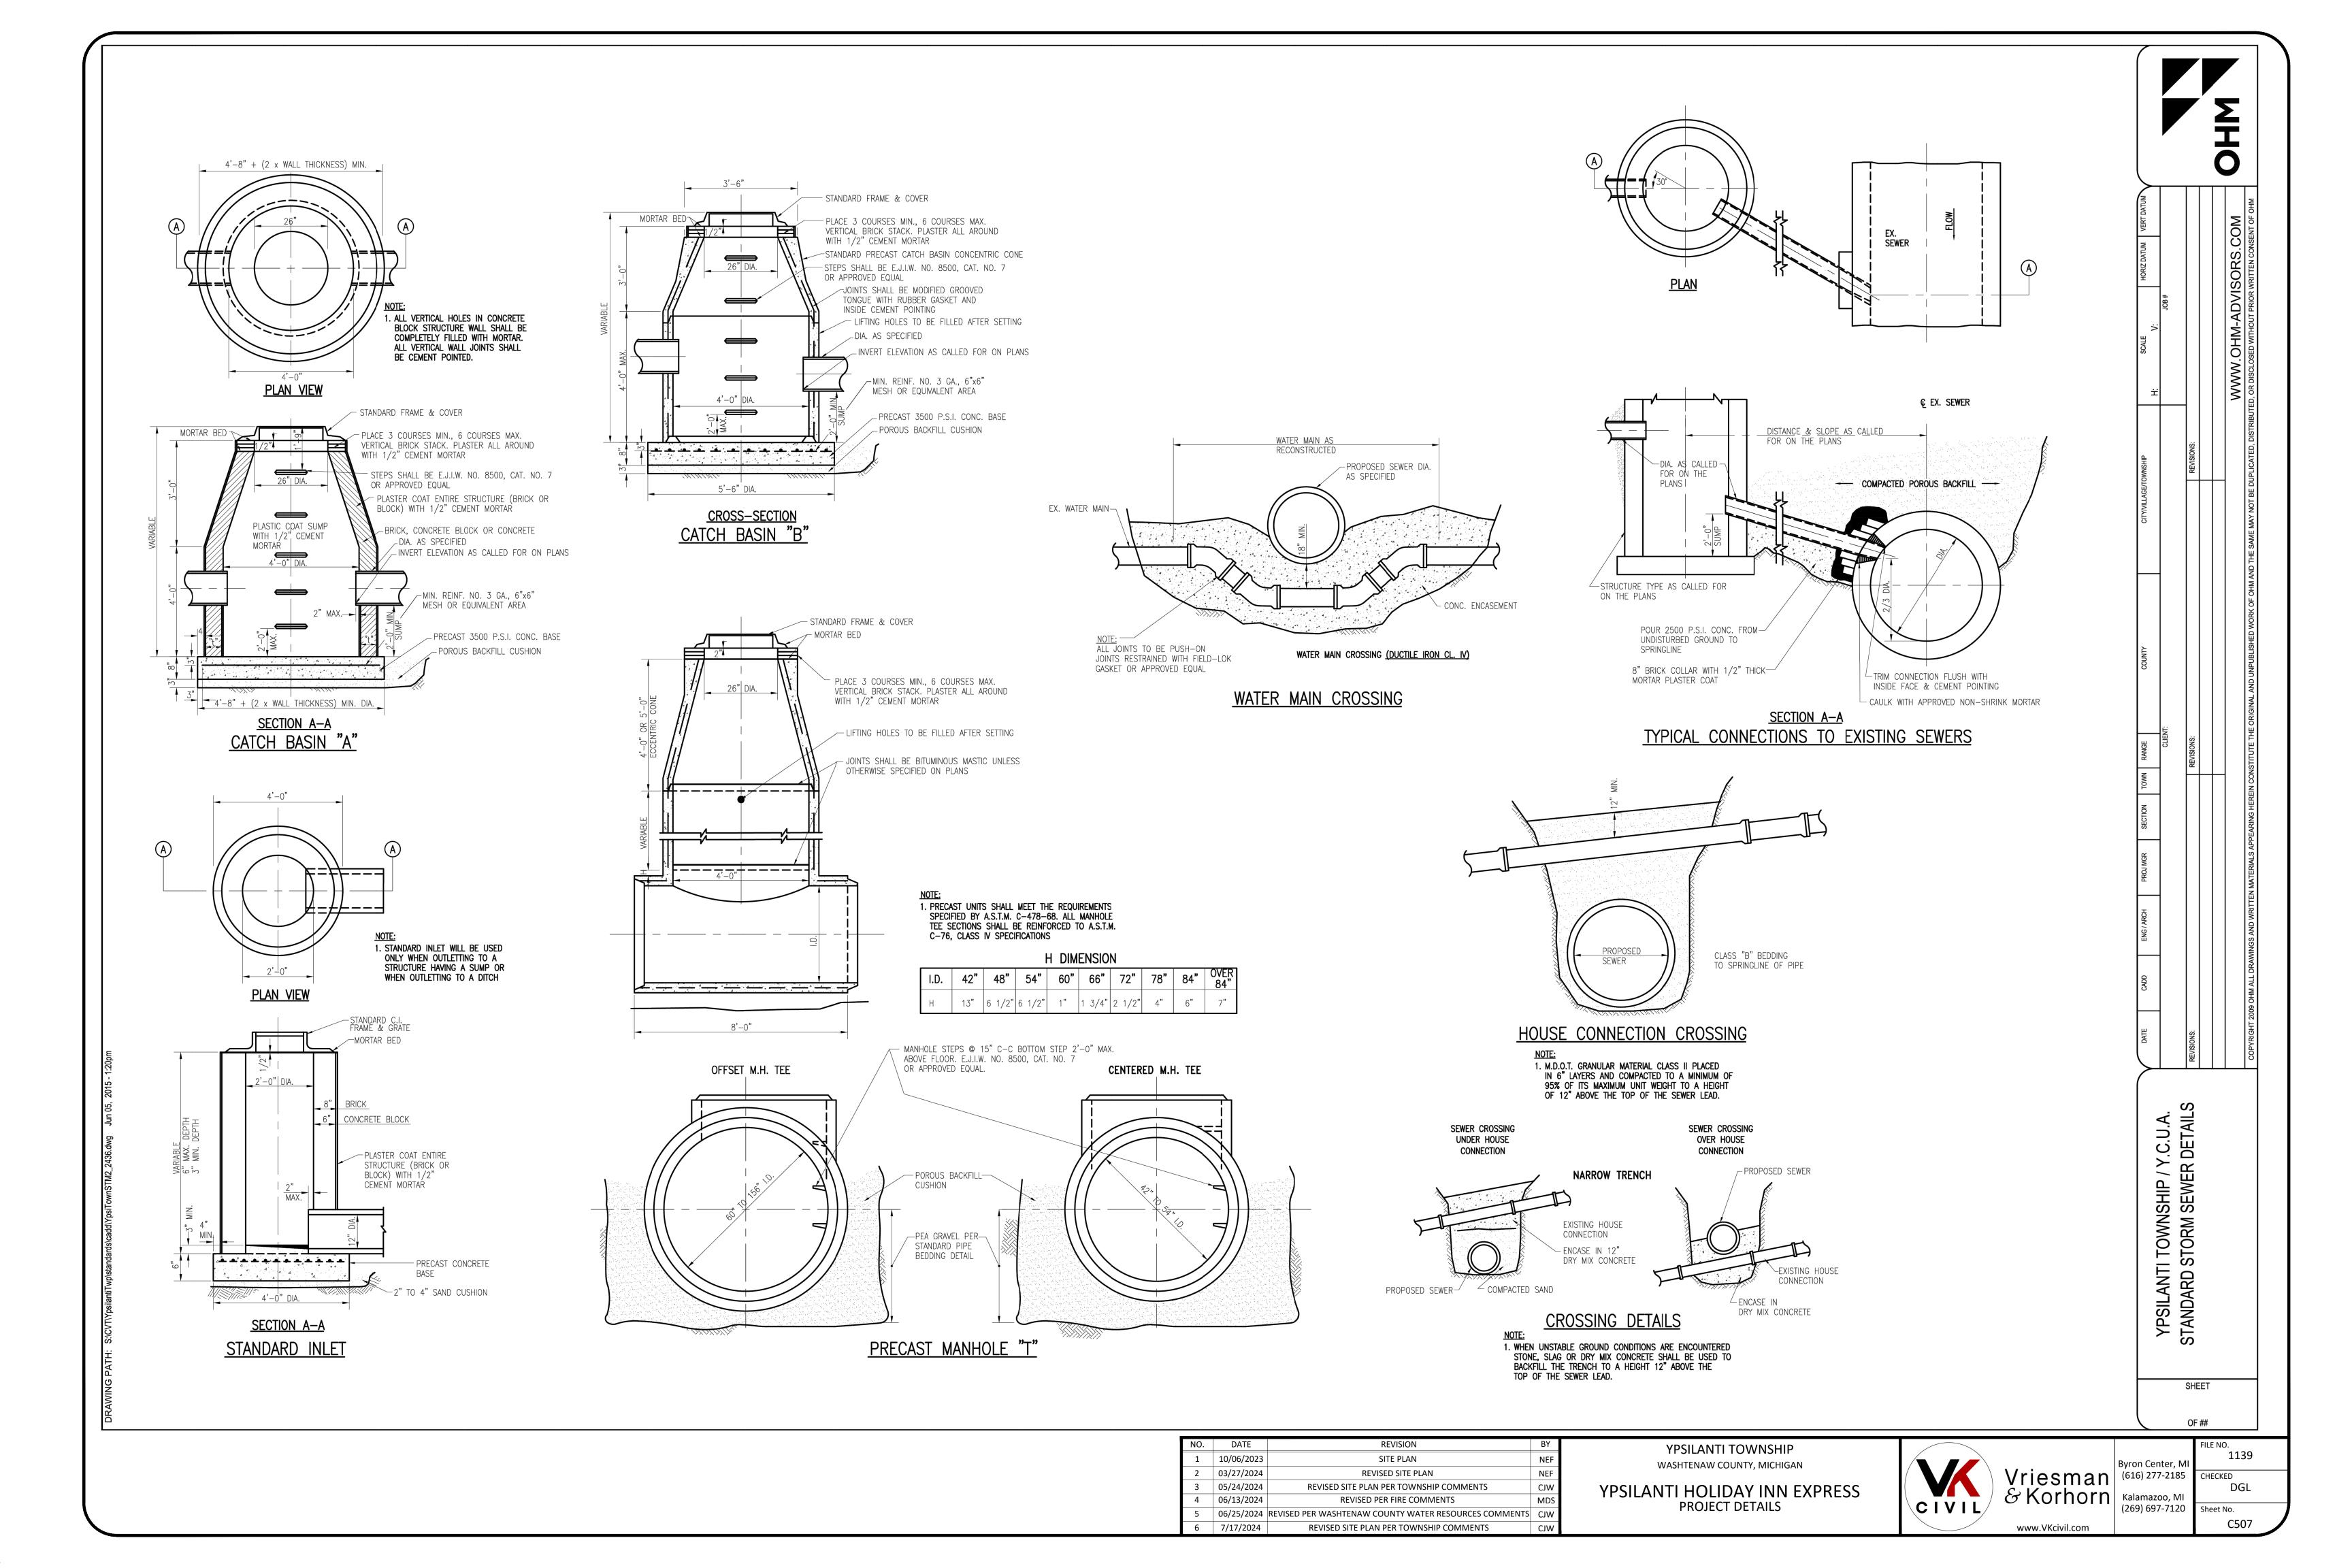

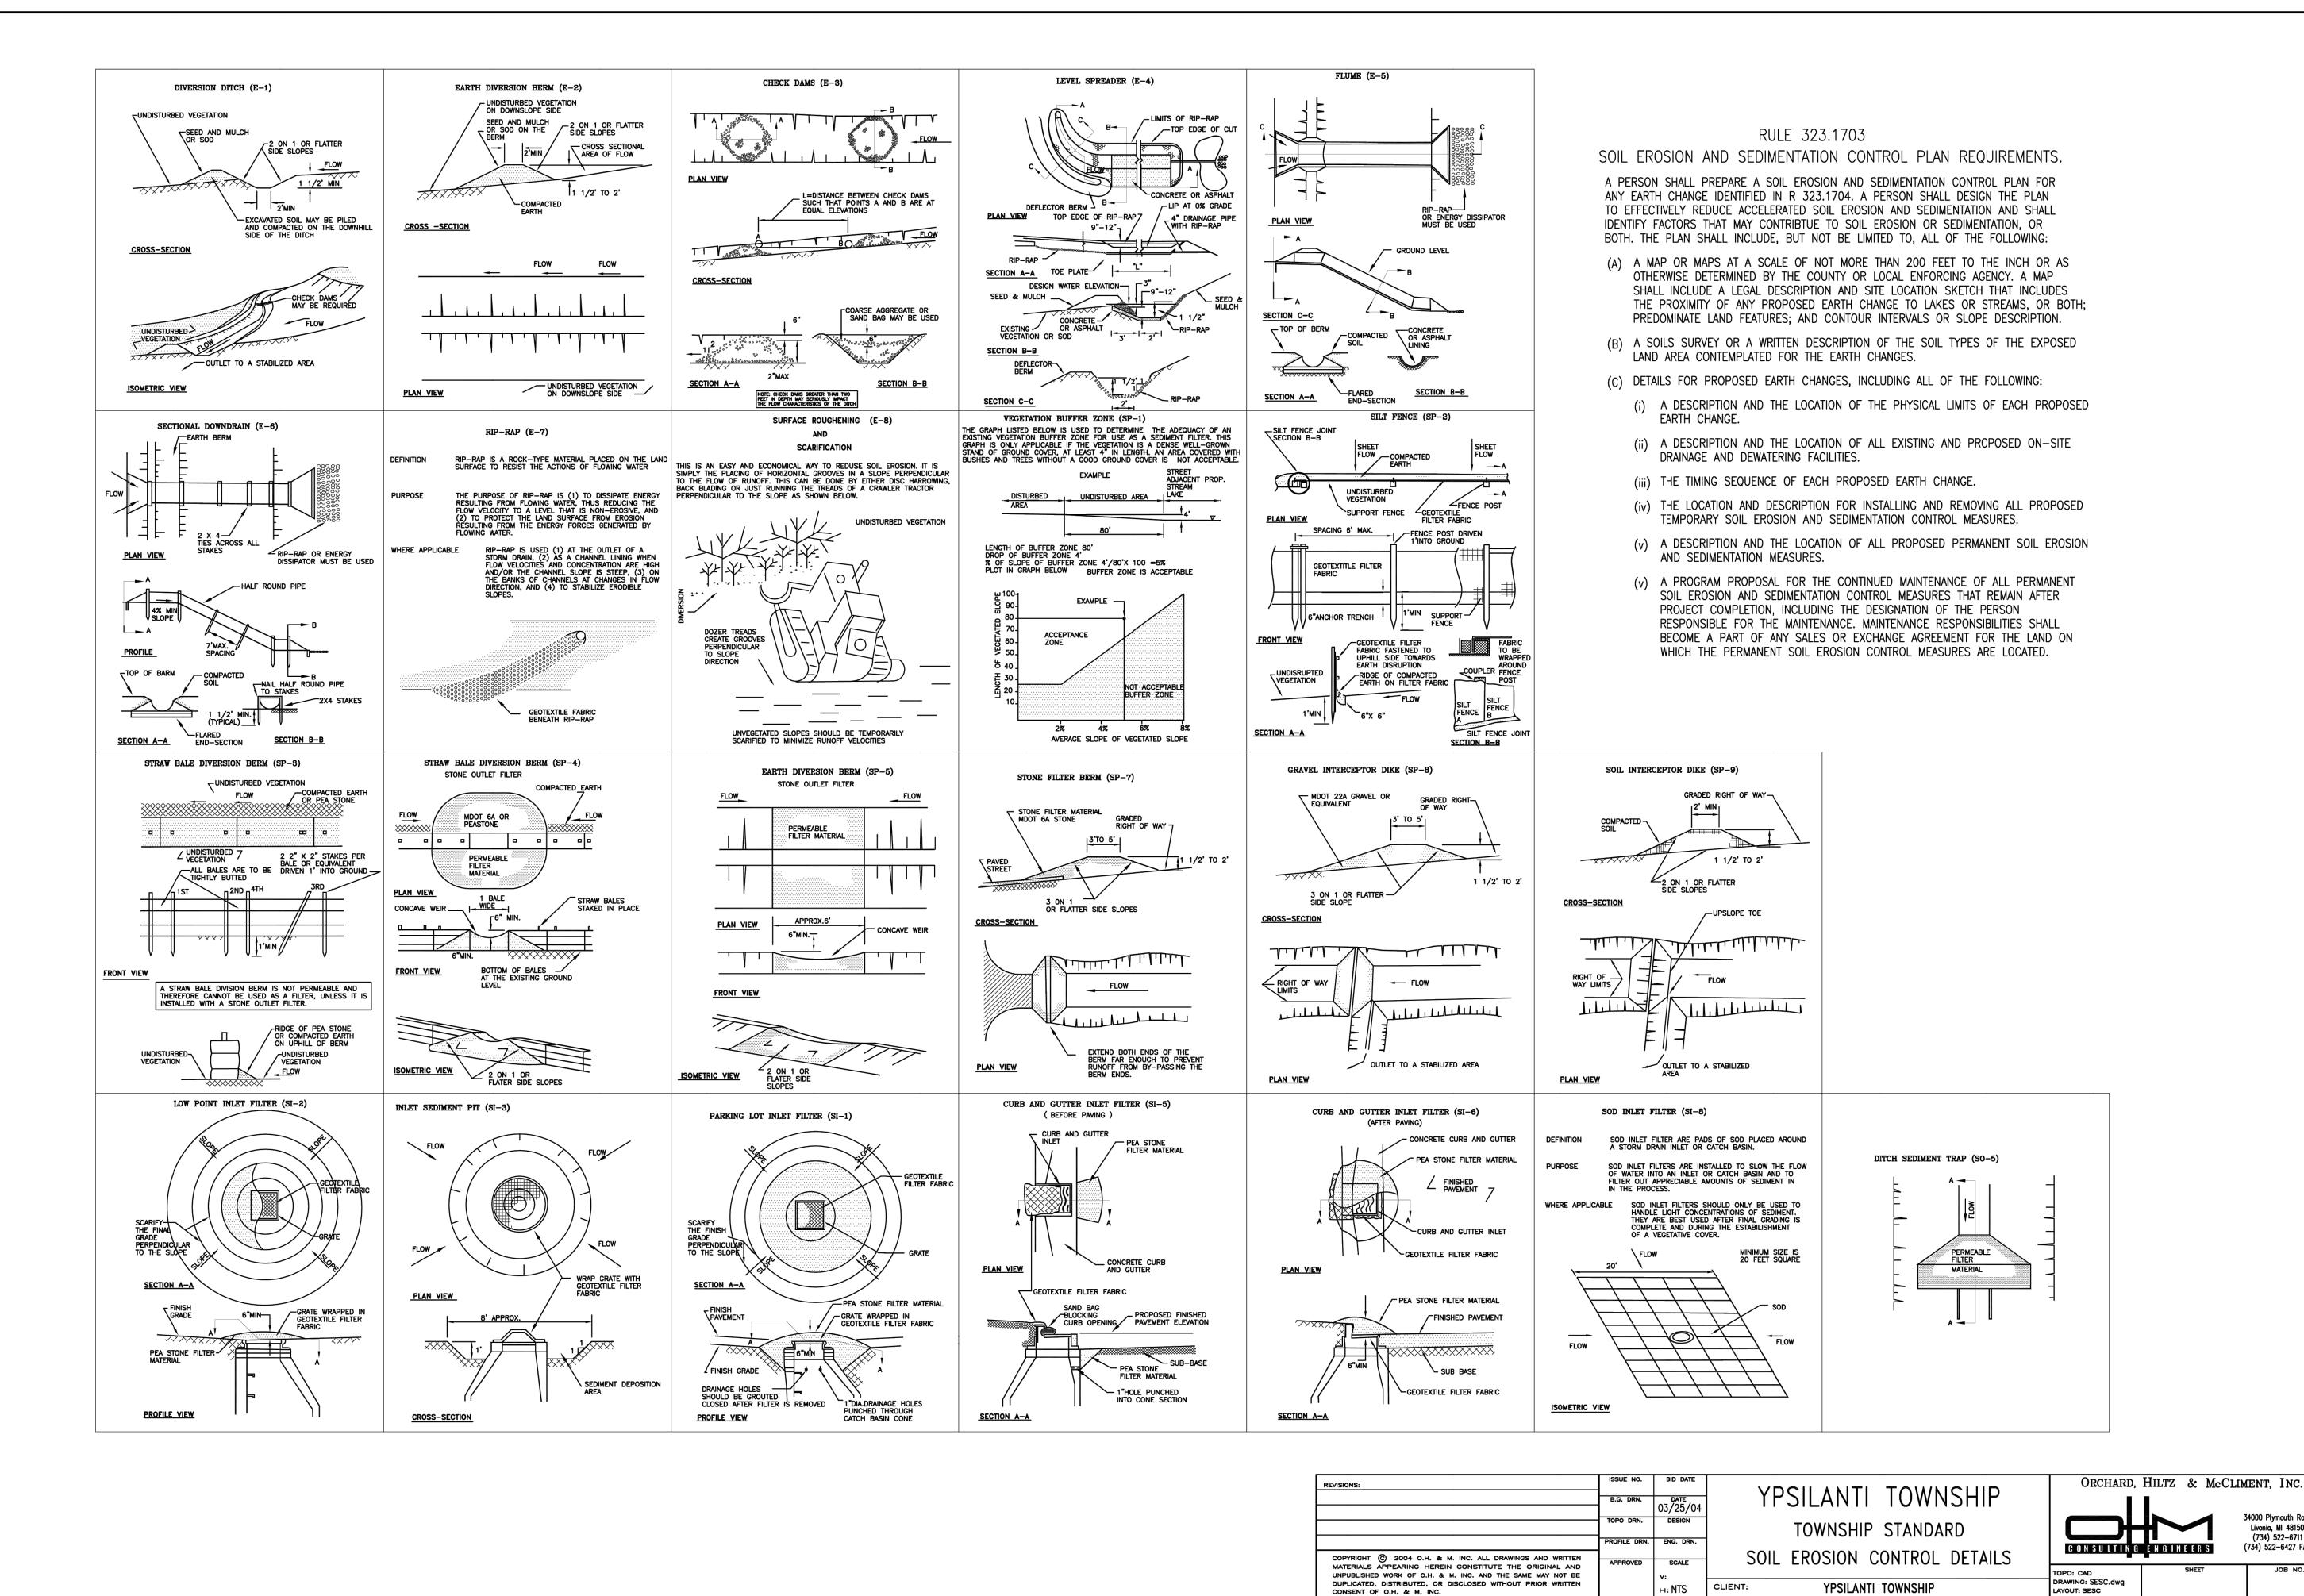

NO.	DATE	REVISION	BY
1	10/06/2023	SITE PLAN	NEF
2	03/27/2024	REVISED SITE PLAN	NEF
3	05/24/2024	REVISED SITE PLAN PER TOWNSHIP COMMENTS	CJW
4	06/13/2024	REVISED PER FIRE COMMENTS	MDS
5	06/25/2024	REVISED PER WASHTENAW COUNTY WATER RESOURCES COMMENTS	CJW
6	7/17/2024	REVISED SITE PLAN PER TOWNSHIP COMMENTS	CJW

YPSILANTI TOWNSHIP WASHTENAW COUNTY, MICHIGAN

YPSILANTI HOLIDAY INN EXPRESS PROJECT DETAILS




Byron Center, M Vriesman (616) 277-2185 CHECKED & Korhorn Kalamazoo, MI (269) 697-7120 Sheet No.


34000 Plymouth Road

Livonia, MI 48150 (734) 522-6711

(734) 522-6427 FAX


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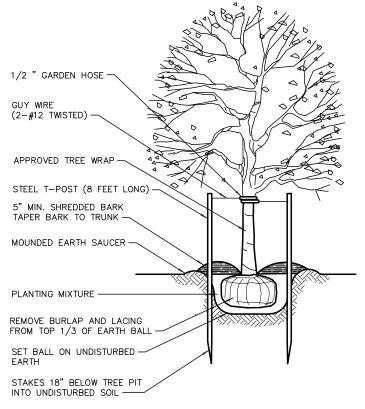


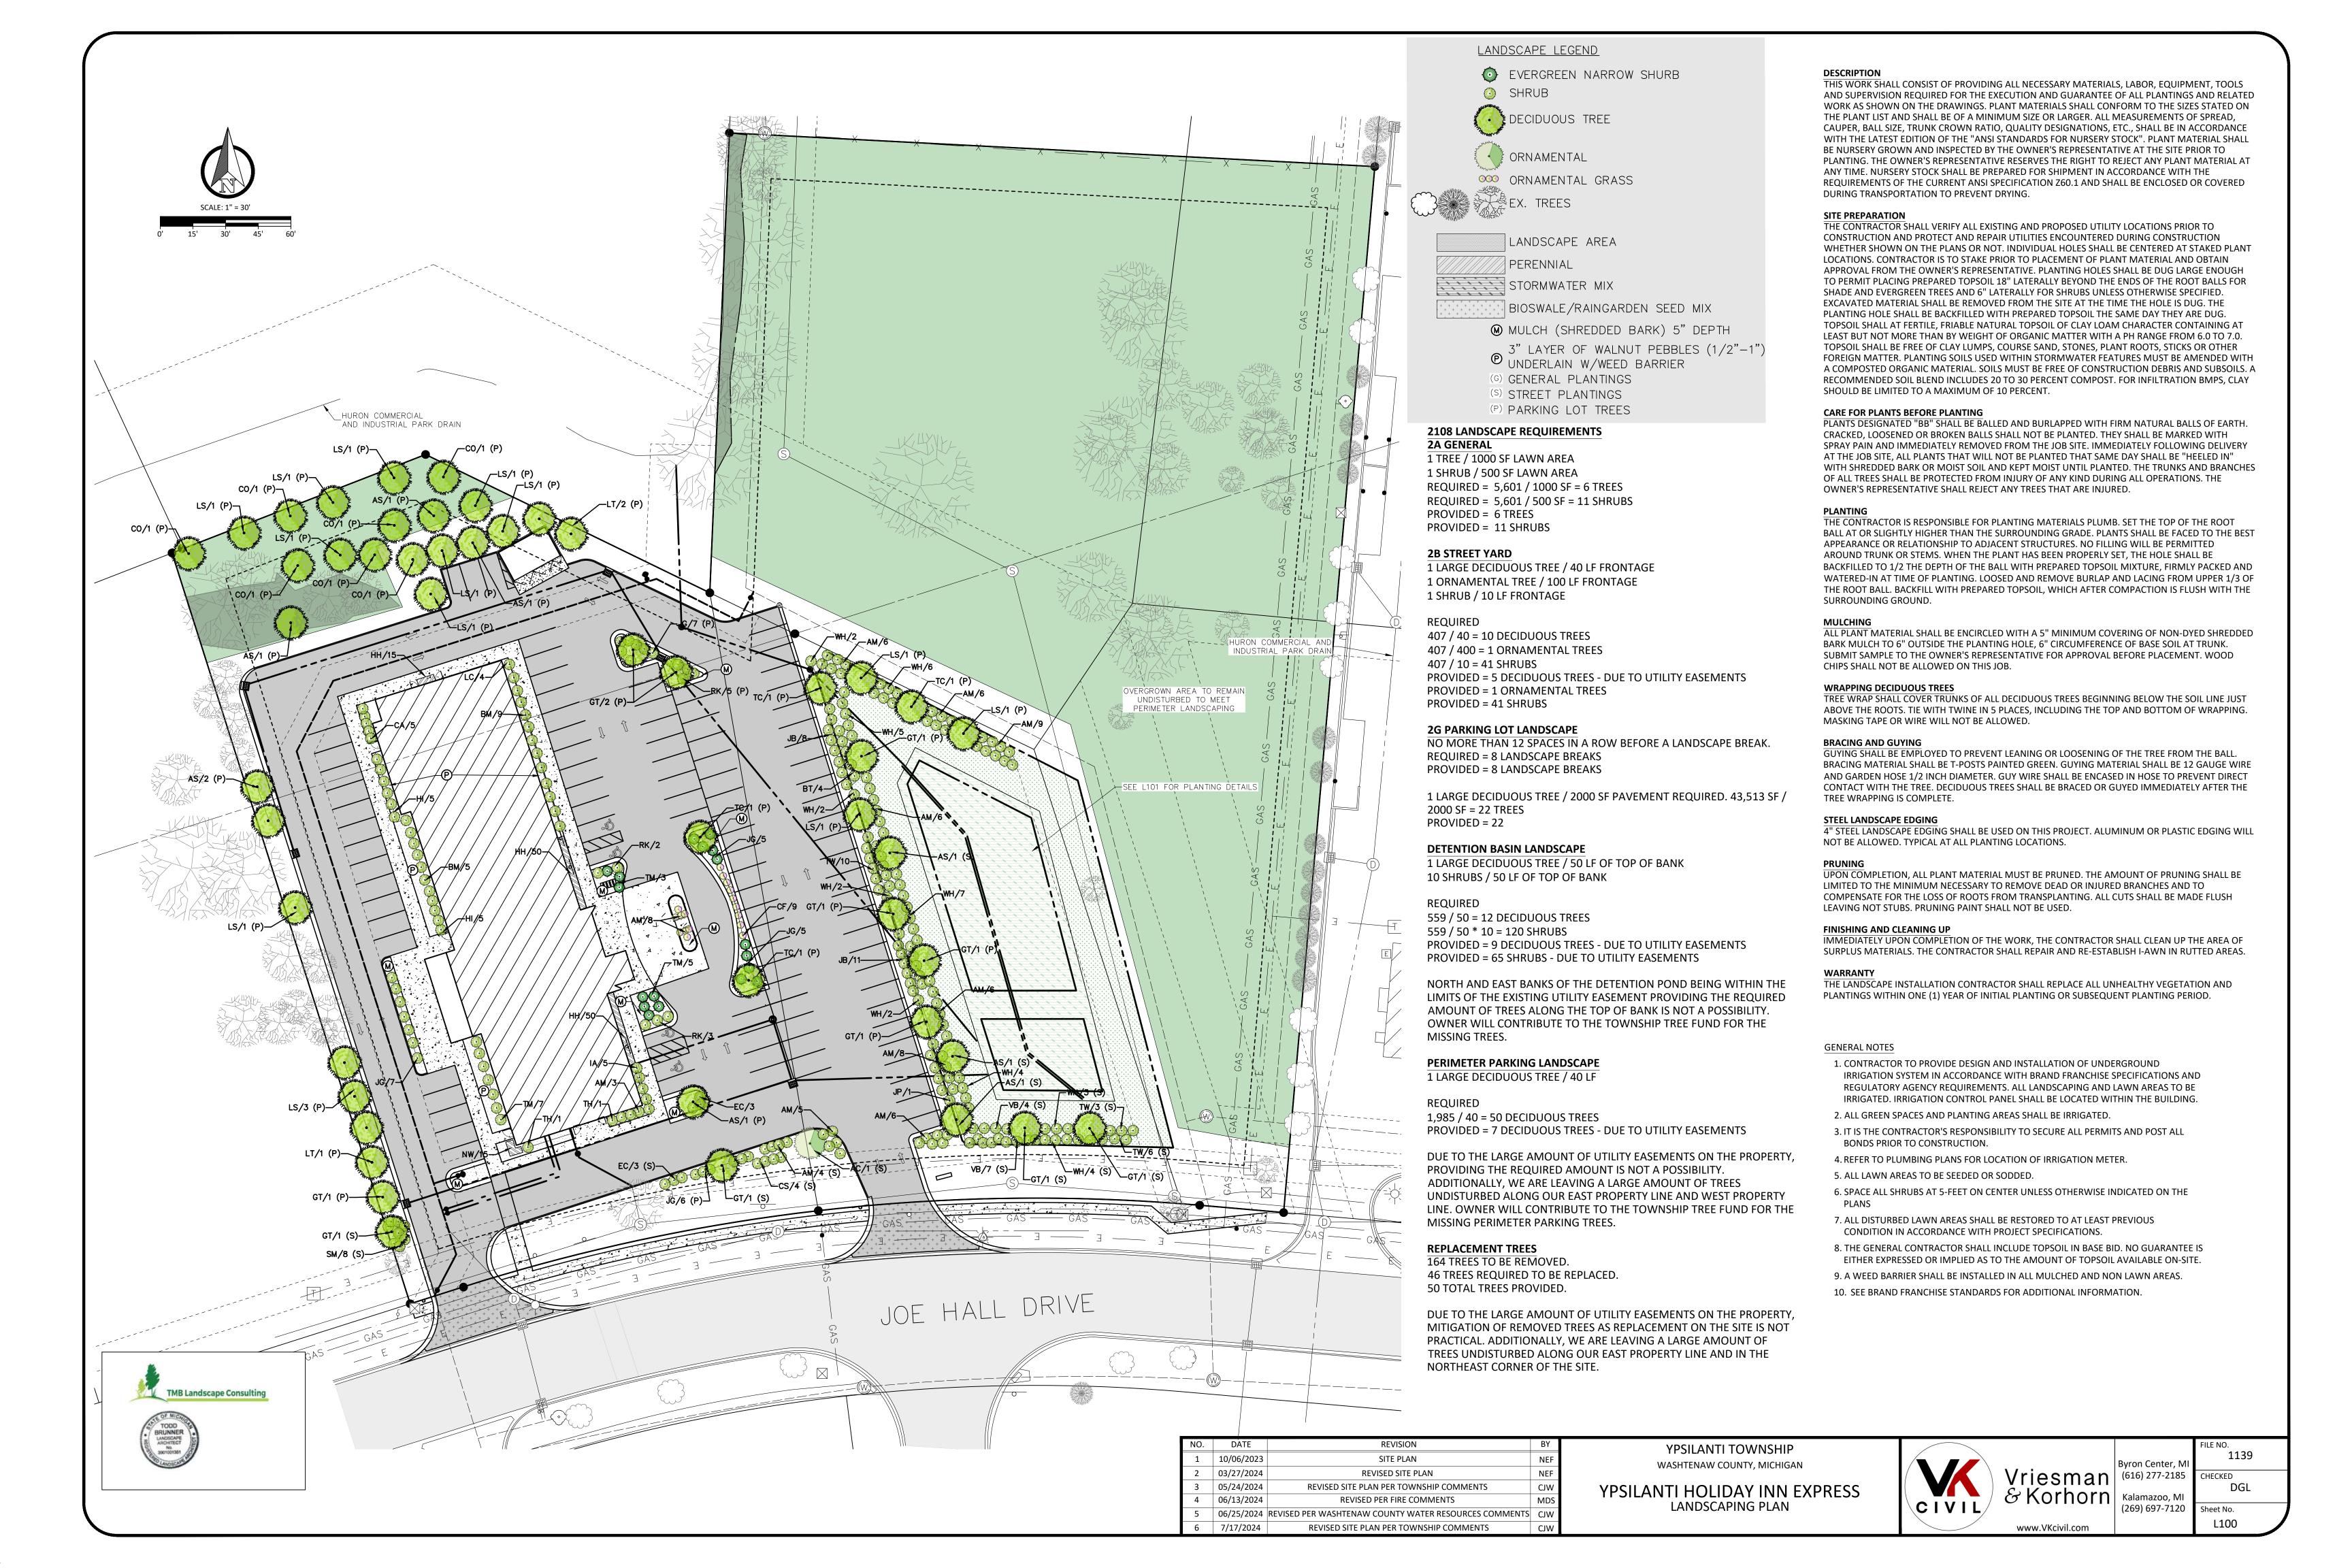

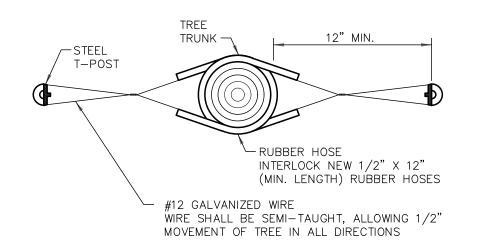
SCALE: NONE



PERENNIAL PLANTING BED SCALE: NONE

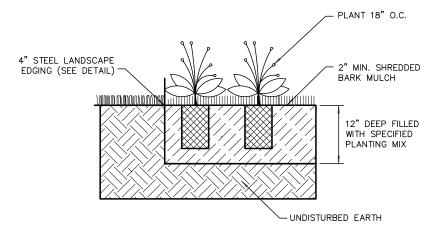


**DECIDUOUS TREE PLANTING** 

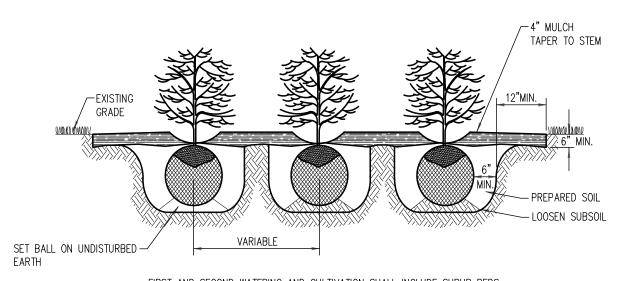



-FIRST AND SECOND WATERING AND CULTIVATION SHALL INCLUDE SHRUB BEDS. -CUT 6" X 12" (MIN.) EDGING AROUND THE PERIMETER OF ALL SHRUB BEDS SHOWN ON THE PLANS. SPRAY A NON-PERSISTANT GLYPHOSATE HERBICIDE TO ENTIRE SHRUB BEDS PRIOR TO PLANTING AND BARK PLACEMENT. -SHRUB BEDS ARE TO BE PAID FOR BY THE PAY ITEM 'SITE PREPARATION'. -ALL PLANTS SHALL BE SET PLUMB AND HAVE THE BEST SIDE OF PLANT FACING THE MAIN VIEWING DIRECTION.


SHRUB BED DETAIL

SCALE: NONE

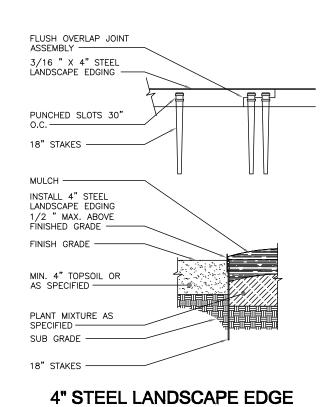

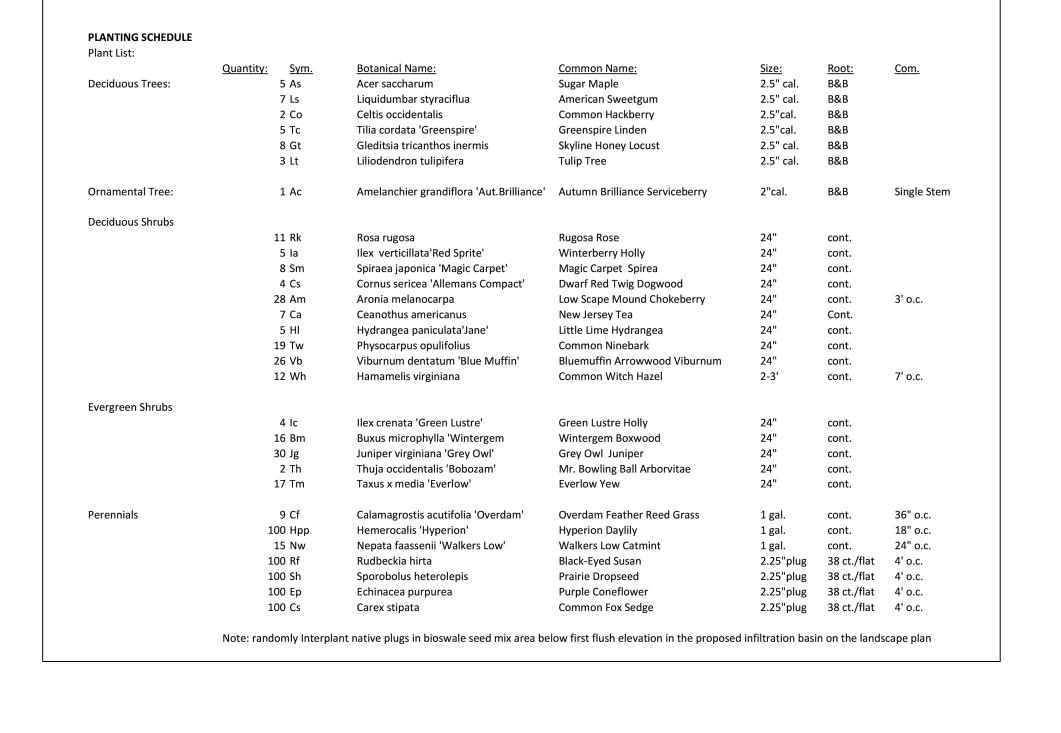

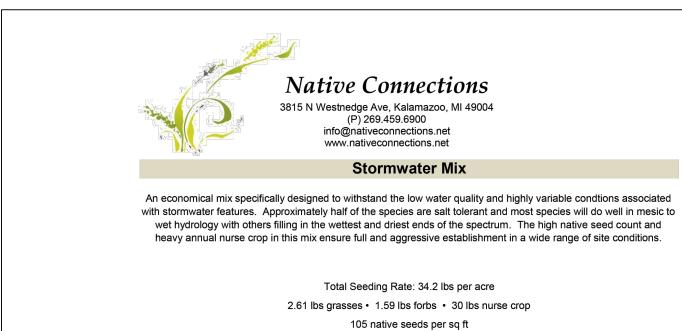

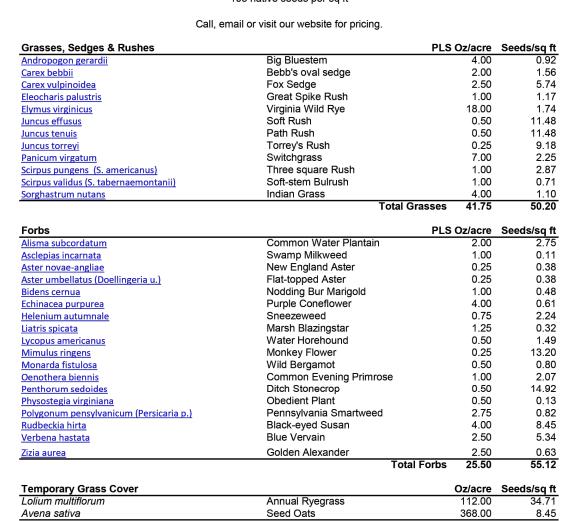



Grasses, Sedges & Rushes

Andropogon gerardii Carex bebbii

#### **BioSwale / Raingarden Seed Mix**

This mix is similar to our Wet-Mesic Prairie, except more specifically designed for swales, detention basins, and raingardens. It has less emphasis on the tallest grasses and more emphasis on the showier, more common wildflowers. For a shorter stature, we can easily customize it by eliminating the tall grasses and increasing the shorter sedges and rushes.

> Total Seeding Rate: 31 lbs per acre 3.75 lbs grasses • 2.25 lbs forbs • 25 lbs nurse crop 63 native seeds per sq ft

> > Call, email or visit our website for pricing.

Big Bluestem

Andropogon gerardii	bly bluestern	0.0	1.30
<u>Carex bebbii</u>	Bebb's oval sedge	3.0	
Carex vulpinoidea	Fox Sedge	4.0	
Elymus canadensis	Canada Wild Rye	16.0	0 1.91
Elymus virginicus	Virginia Wild Rye	16.0	0 1.54
Glyceria striata	Fowl Manna Grass	0.5	1.84
Juncus effusus	Soft Rush	0.2	5.74
Juncus tenuis	Path Rush	0.2	5.74
Panicum virgatum	Switchgrass	4.0	0 1.29
Sorghastrum nutans	Indian Grass	6.0	0 1.65
Spartina pectinata	Prairie Cordgrass	4.0	0.61
	-	Total Grasses 60.0	0 33.21
Forbs		PLS Oz/acr	e Seeds/sq ft
Allium cernuum	Nodding Wild Onion	2.0	0.35
Asclepias incarnata	Swamp Milkweed	1.0	0.11
Aster novae-angliae	New England Aster	0.2	5 0.38
Cassia hebecarpa	Wild Senna	4.0	0.13
Desmodium canadense	Showy Tick Trefoil	0.5	0.06
Echinacea purpurea	Purple Coneflower	8.0	0 1.21
Eupatorium purpureum	Sweet Joe Pye Weed	0.2	5 0.24
Heliopsis helianthoides	False sunflower	8.0	0 1.16
Hypericum pyramidatum	Great St John's Wort	0.5	0 2.18
Lobelia siphilitica	Great Blue Lobelia	0.5	5.74
Monarda fistulosa	Wild Bergamot	0.5	0.80
Pycnanthemum virginianum	Mountain mint	0.2	.5 1.26
Ratibida pinnata	Yellow Coneflower	1.5	0 1.03
Rudbeckia hirta	Black-eyed Susan	5.0	0 10.56
Solidago riddellii	Riddell's Goldenrod	0.5	0 1.07
Verbena hastata	Blue Vervain	1.5	3.20
Zizia aurea	Golden Alexander	1.7	5 0.44
		Total Forbs 36.0	0 29.93
Temporary Grass Cover		Oz/acı	e Seeds/sqft
Lolium multiflorum	Annual Ryegrass	80.0	
Avena sativa	Seed Oats	320.0	0 7.35
	Tota	l Temp Grasses 400.0	0 32.14

١٥.	DATE	REVISION	BY
1	10/06/2023	SITE PLAN	NEF
2	03/27/2024	REVISED SITE PLAN	NEF
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6 7/17/2024

YPSILANTI TOWNSHIP WASHTENAW COUNTY, MICHIGAN

YPSILANTI HOLIDAY INN EXPRESS LANDSCAPING PLAN



 PLS Oz/acre
 Seeds/sq ft


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 1.38

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	(269) 697-7120	Sheet No.
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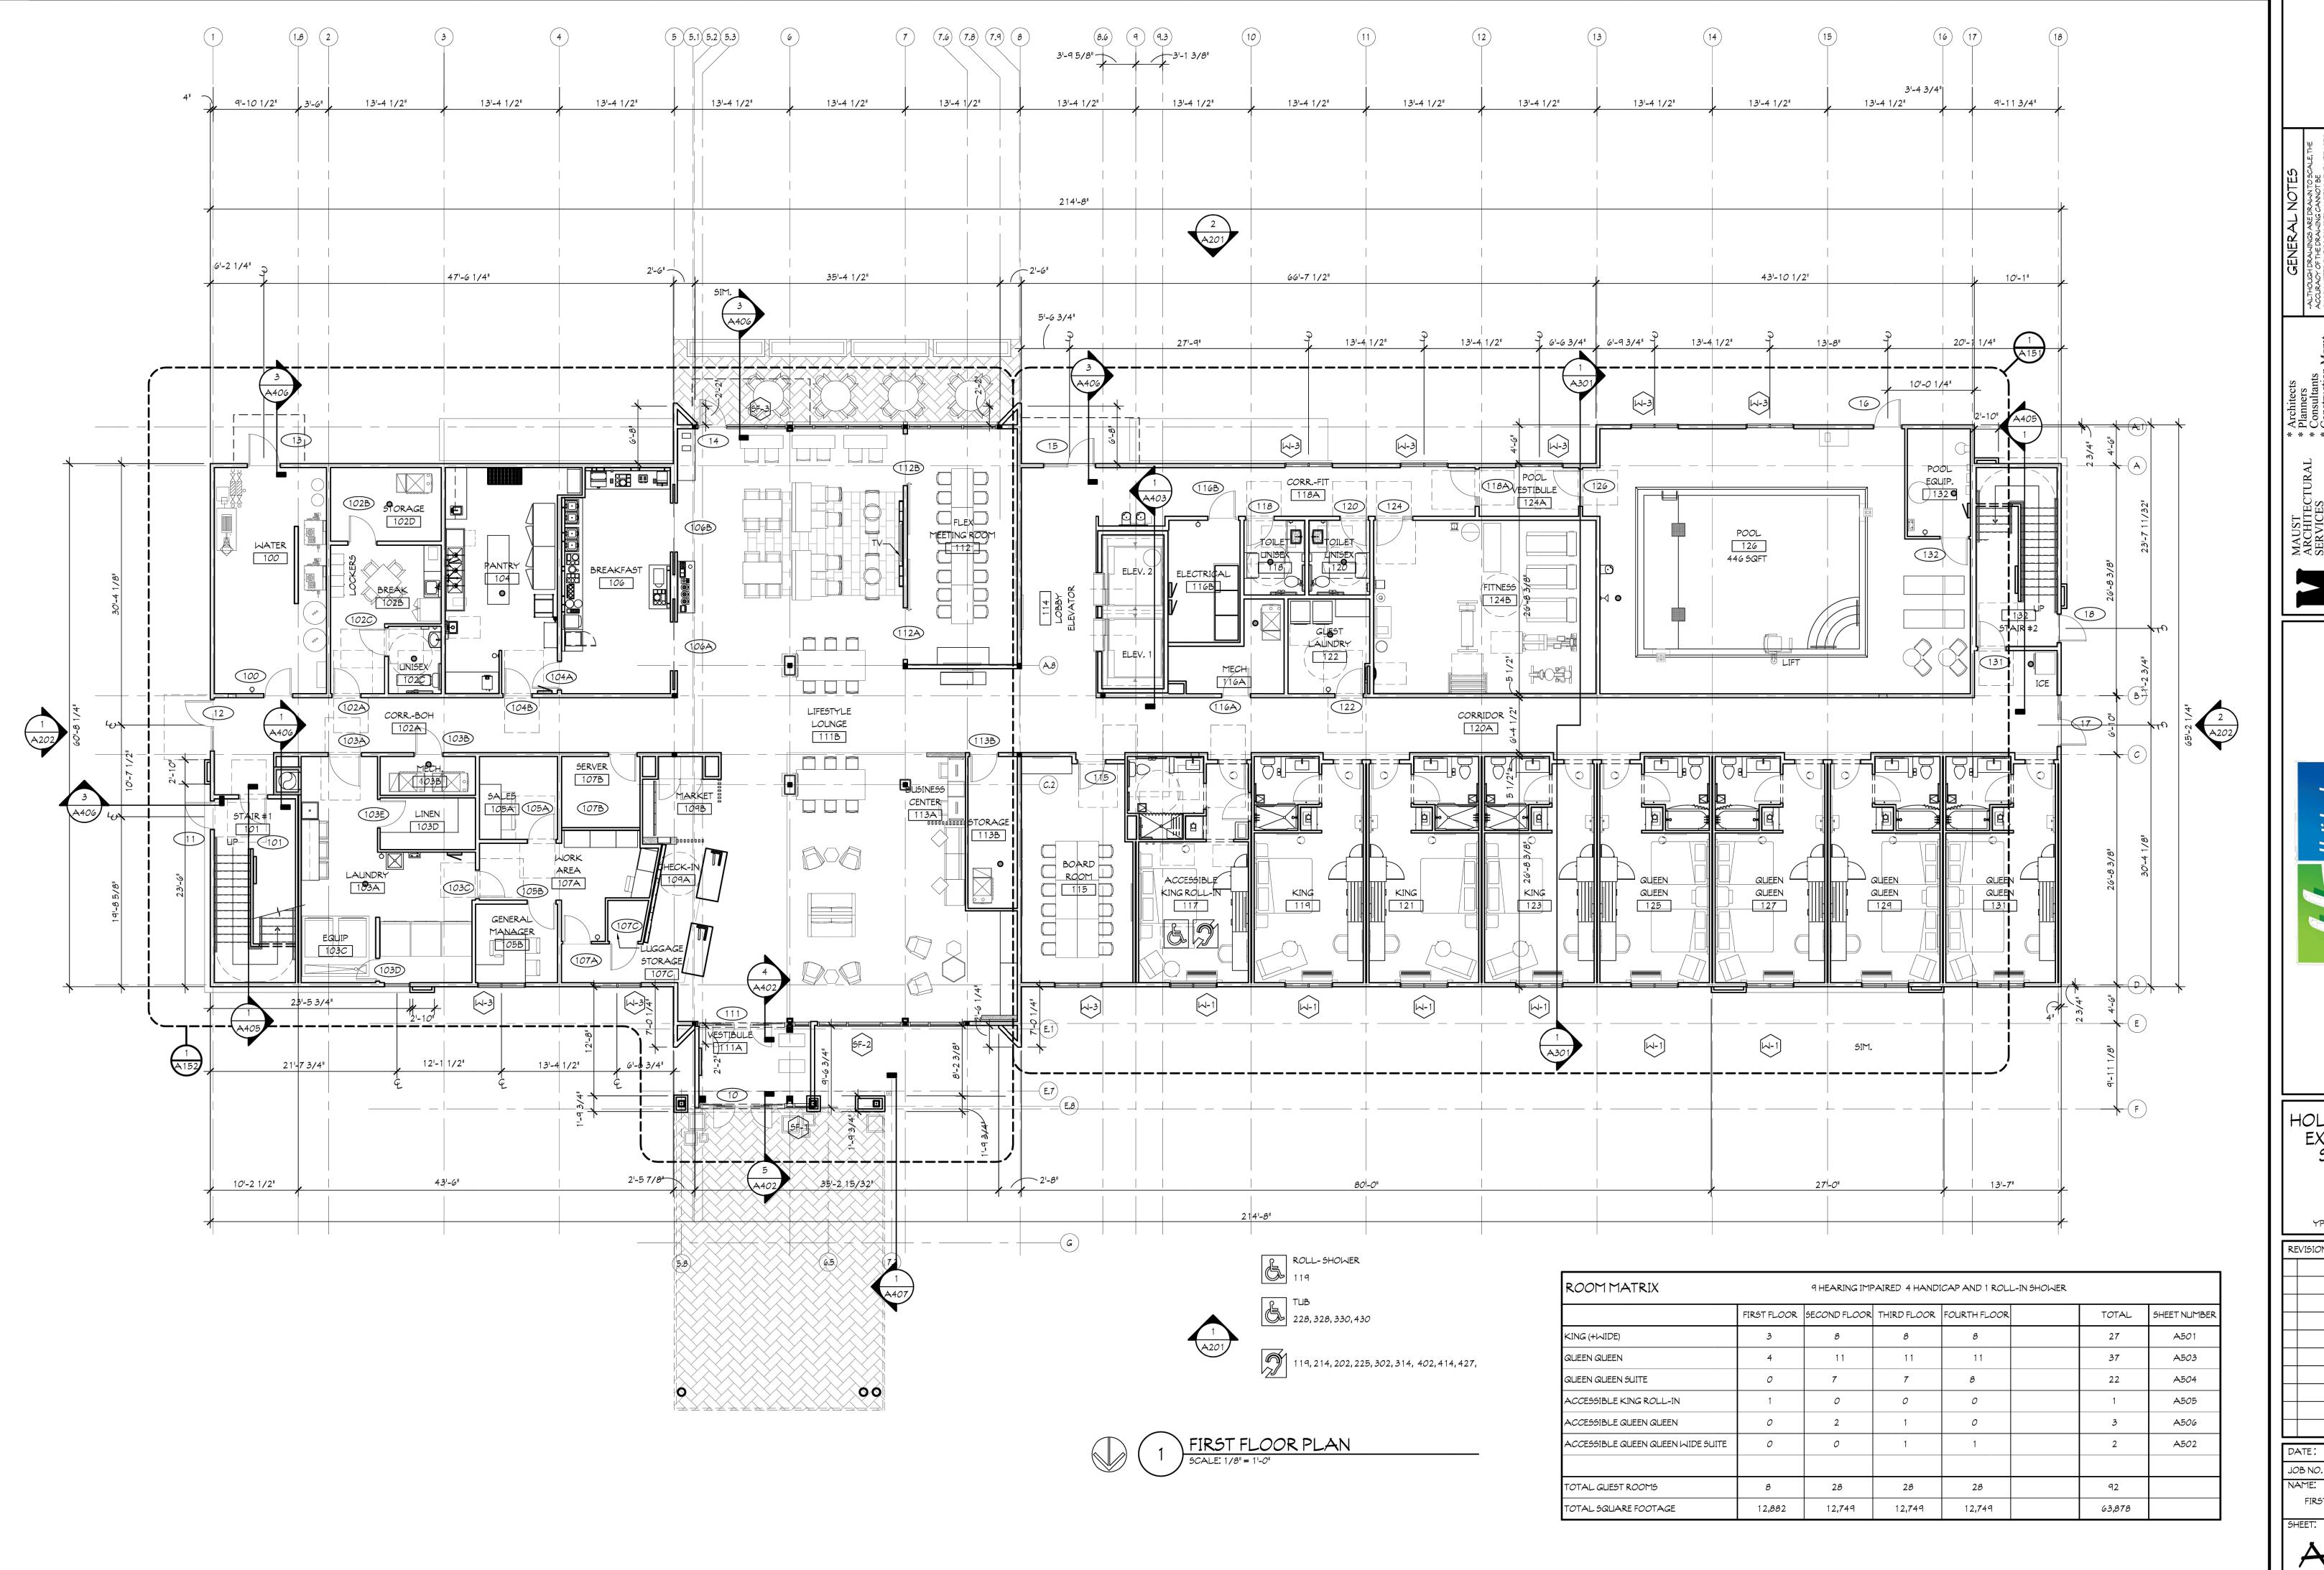
HOLIDAY INN EXPRESS & SUITES

YPSILANTI, MI

REVISIONS:

DATE: 2-24-24 JOB NO.: MAS-23-119 SITE PHOTOMETRIC

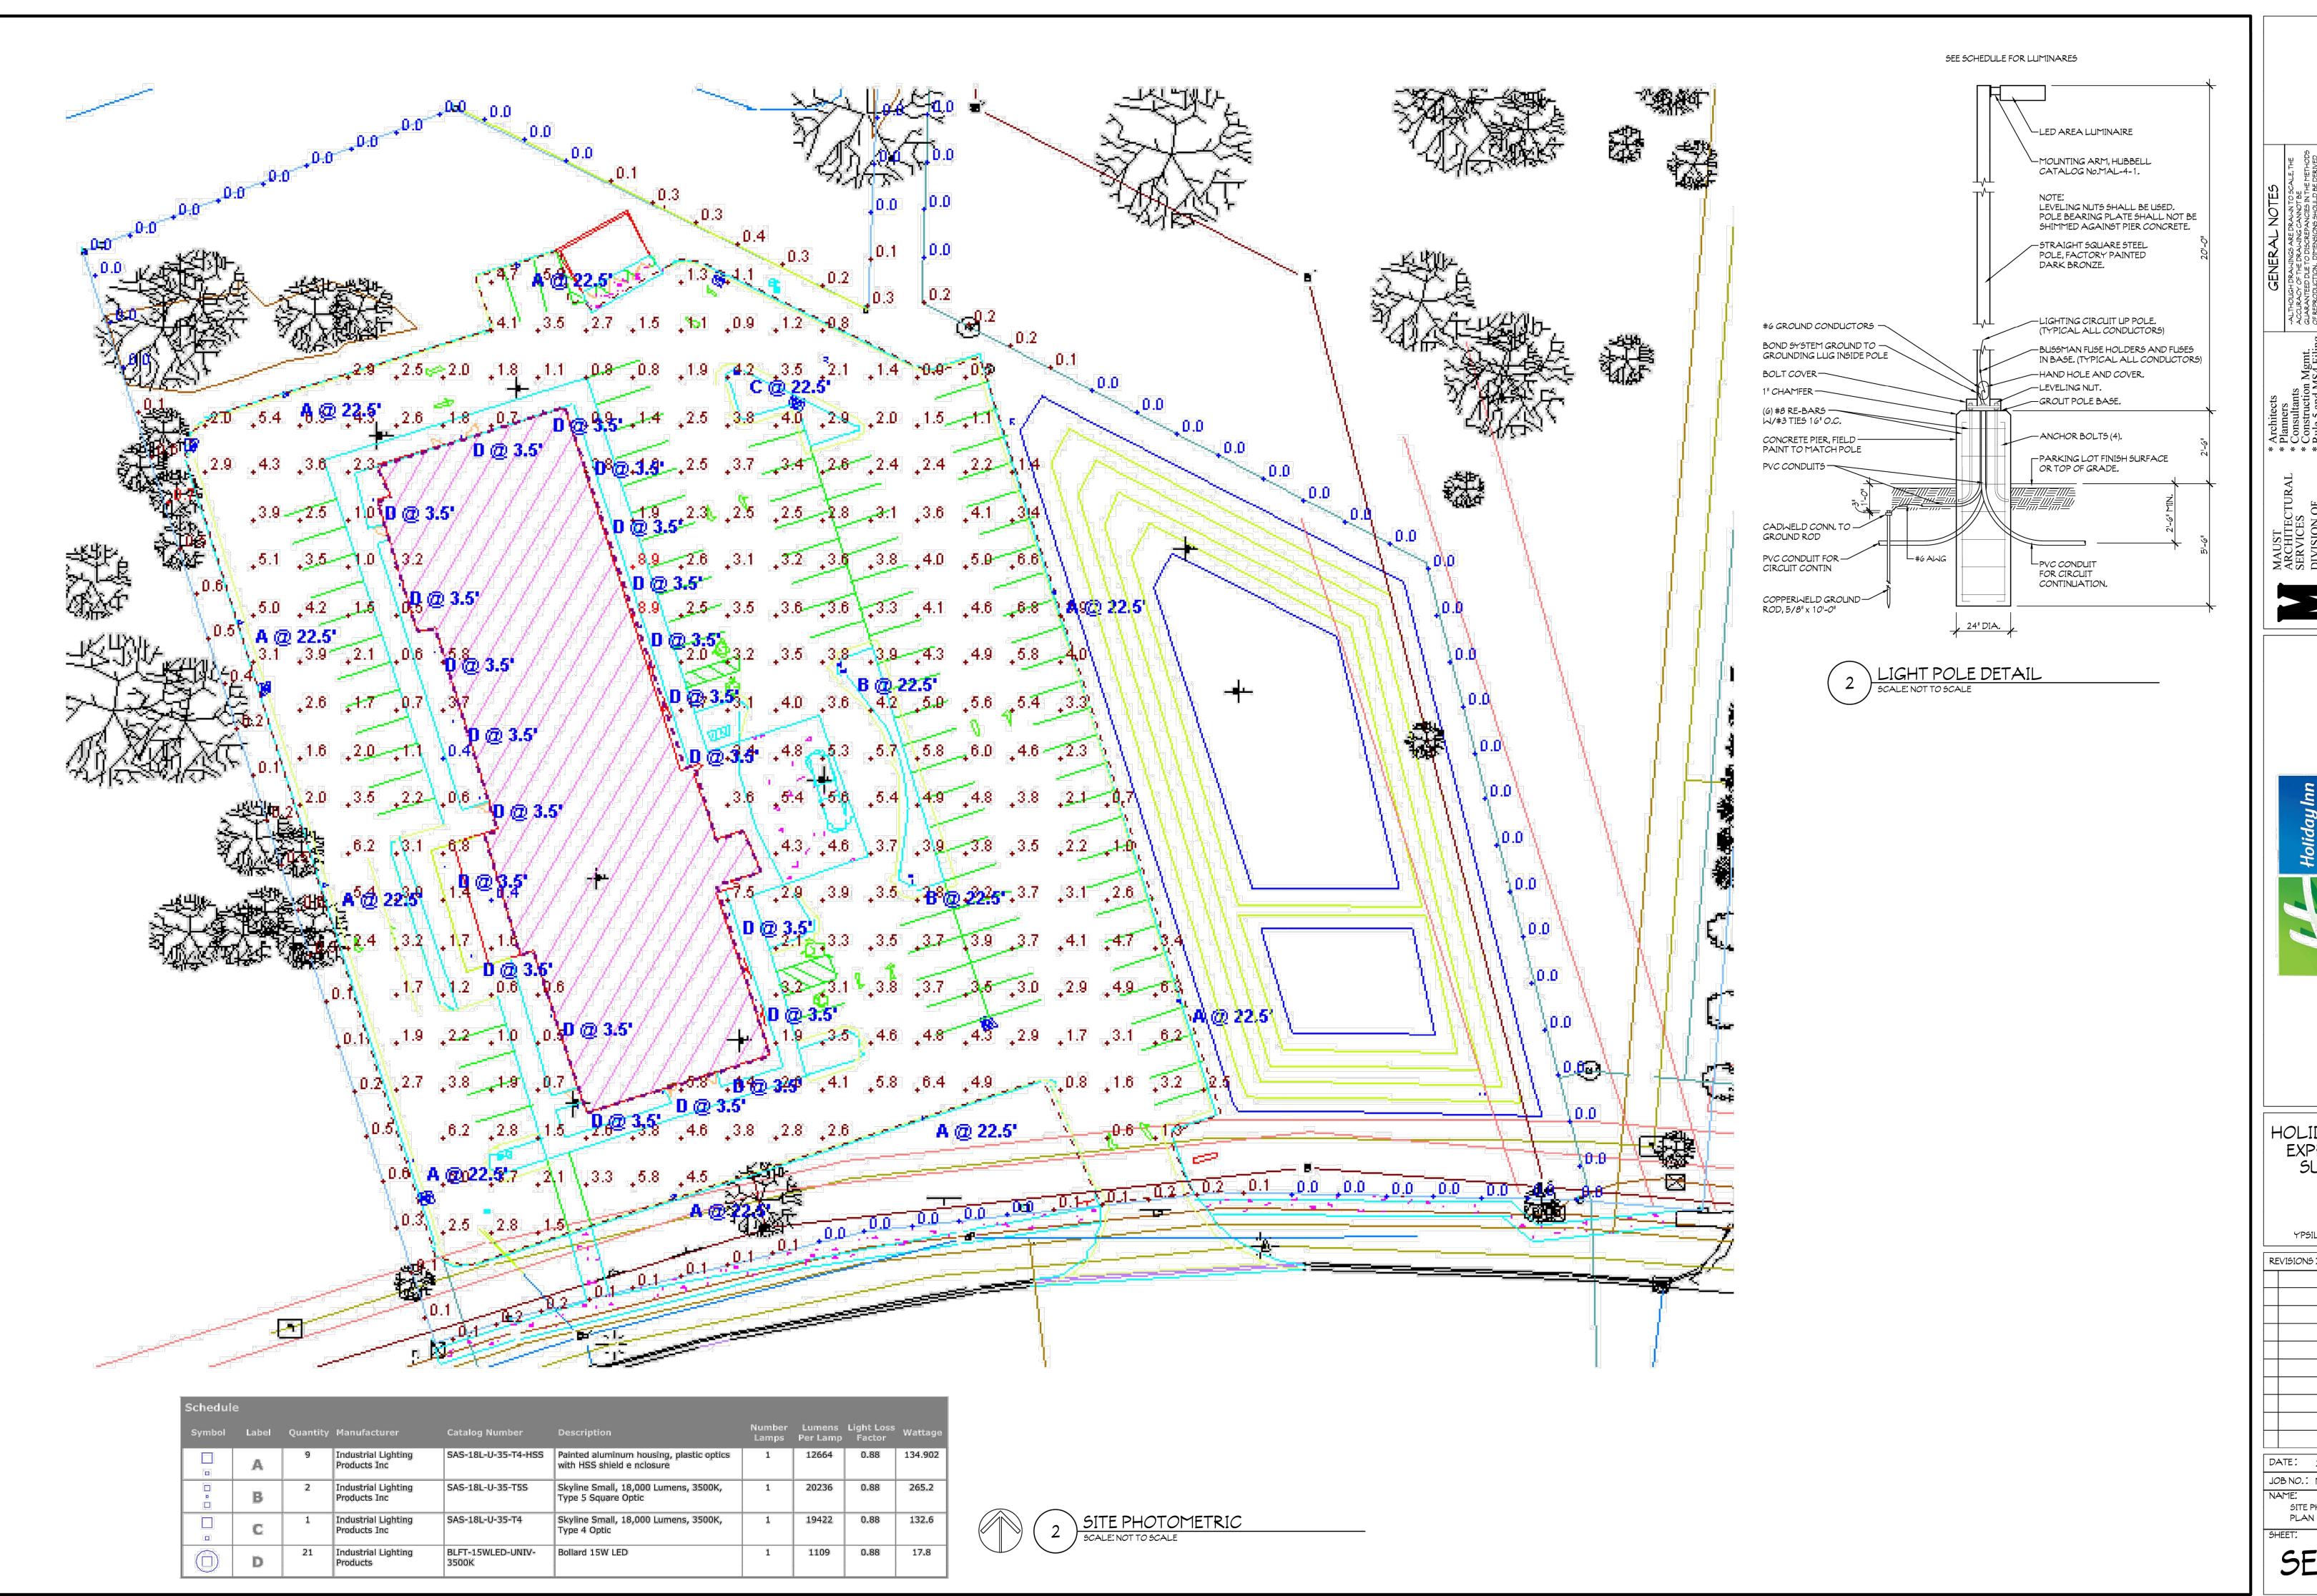SE101



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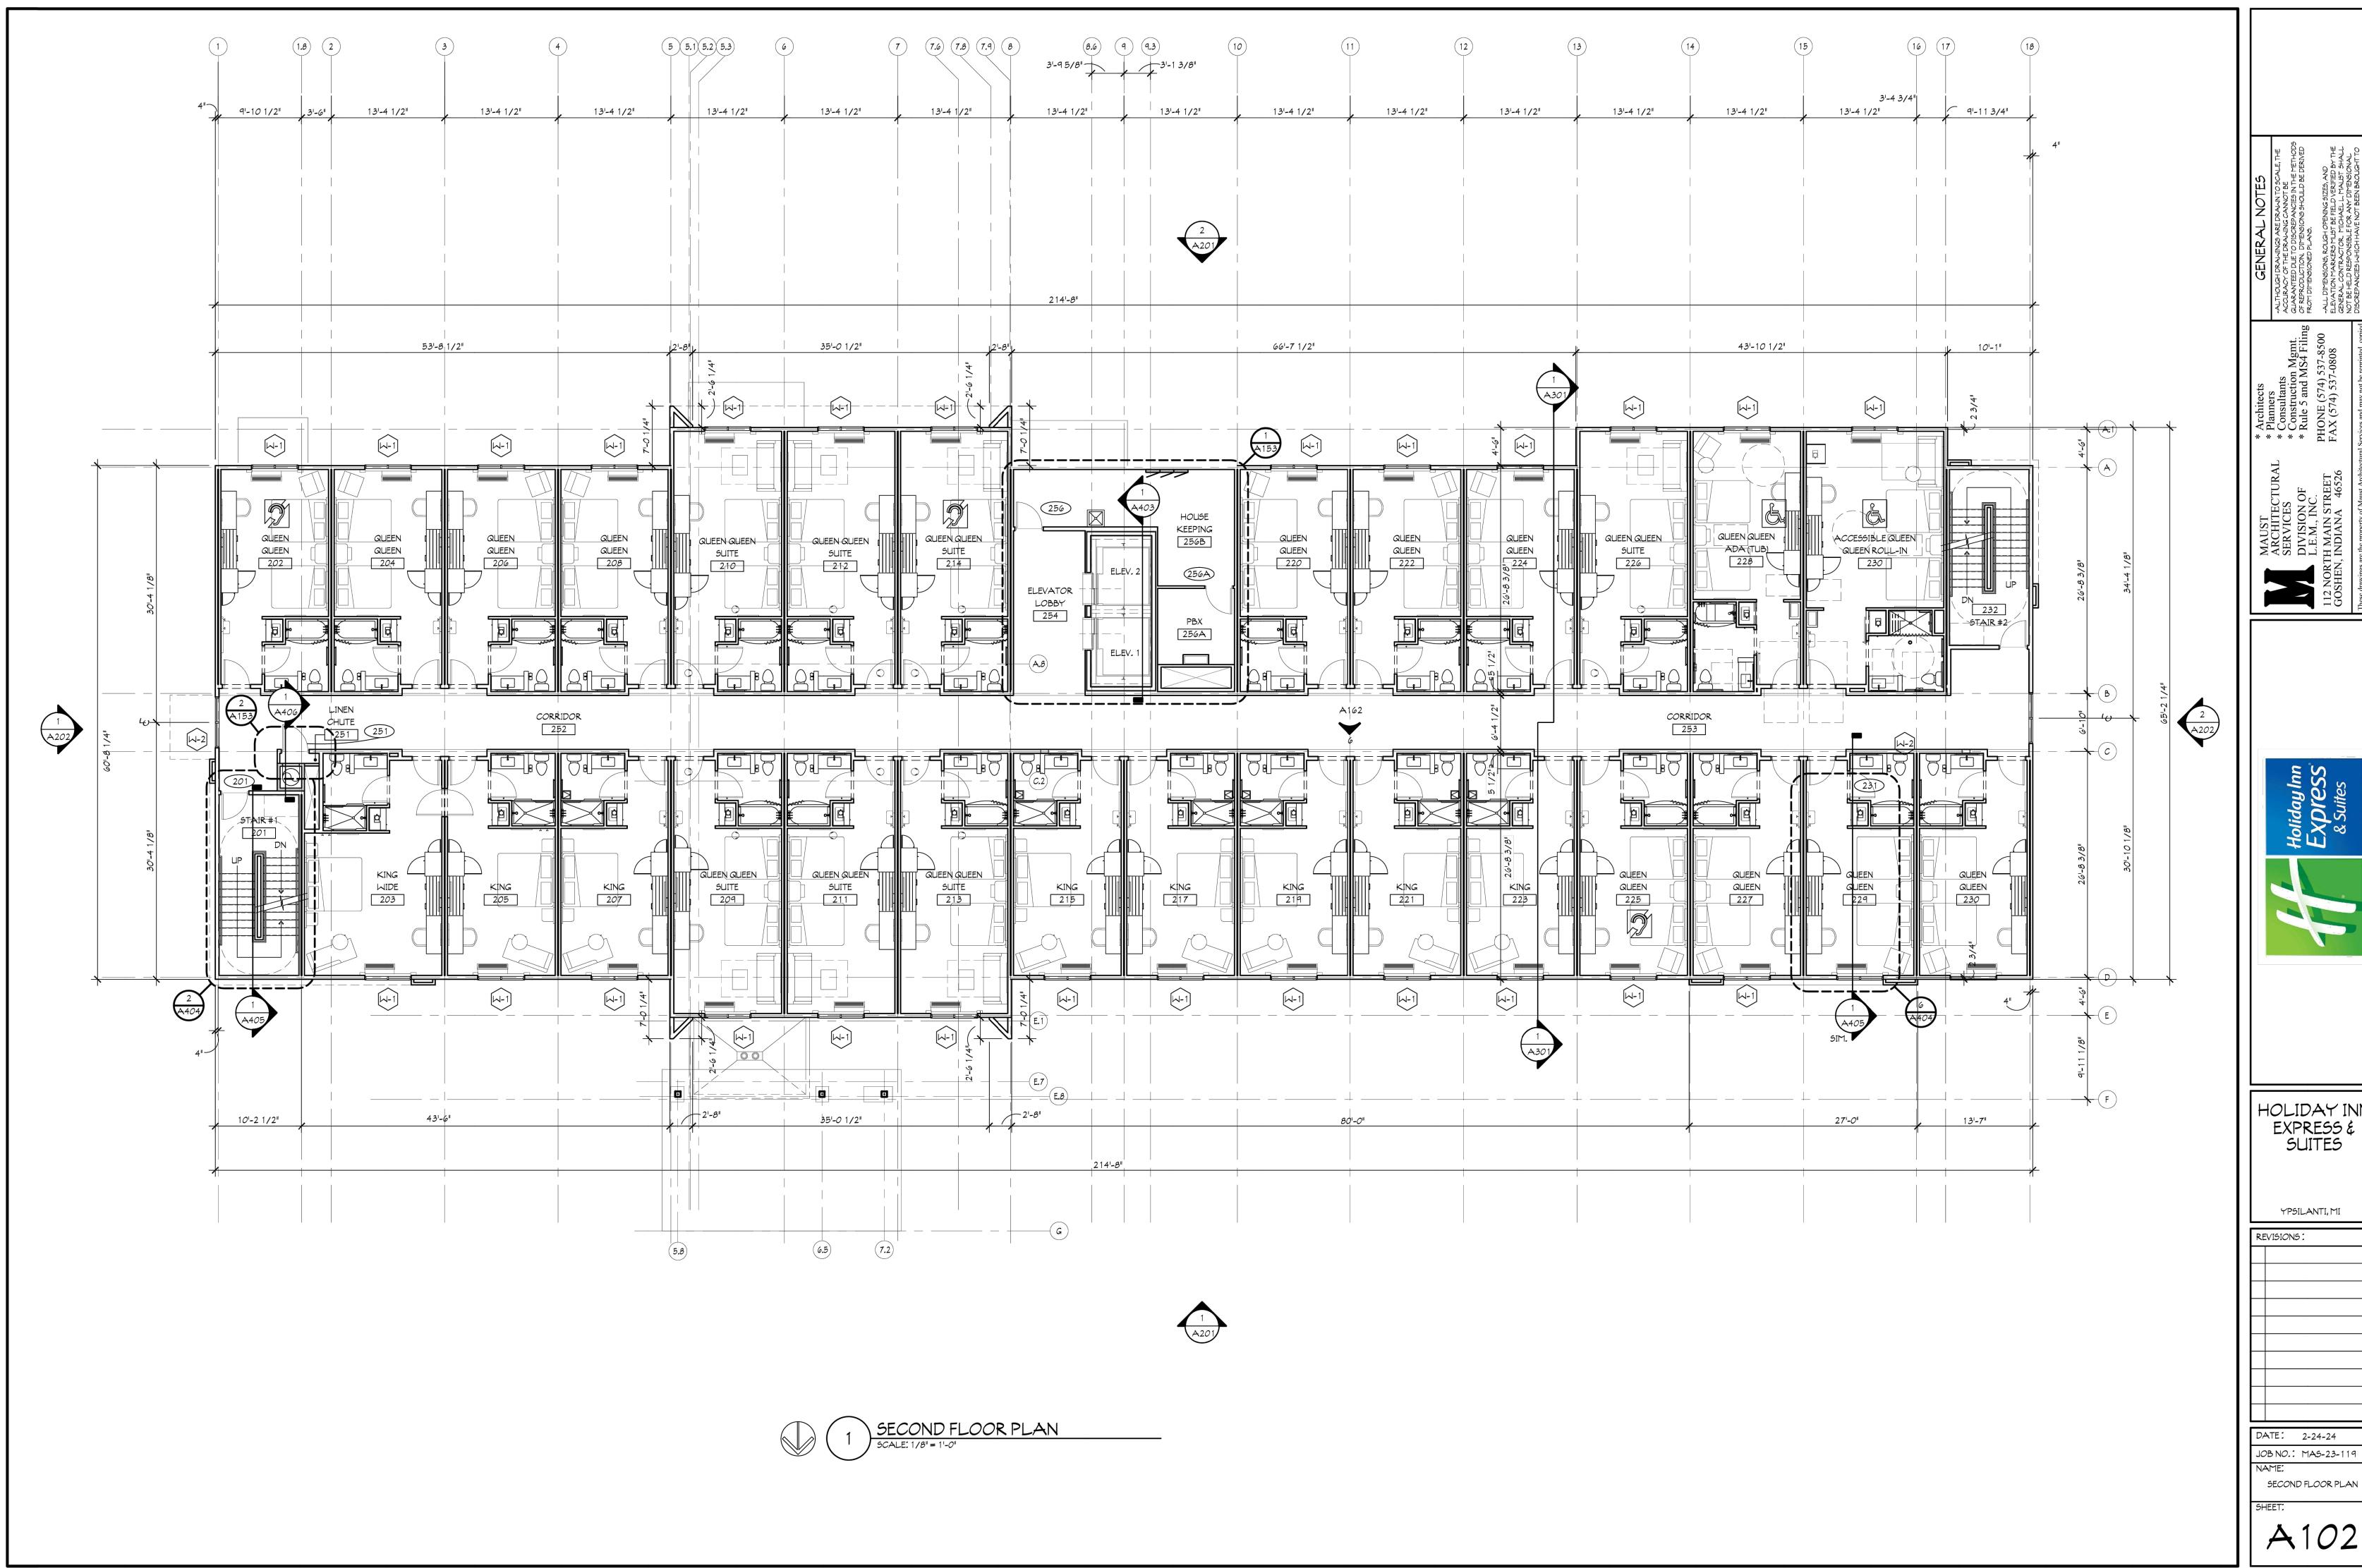
HOLIDAY INN EXPRESS & SUITES

YPSILANTI, MI

REVISIONS:

DATE: 2-24-24 JOB NO.: MAS-23-119 FIRST FLOOR PLAN


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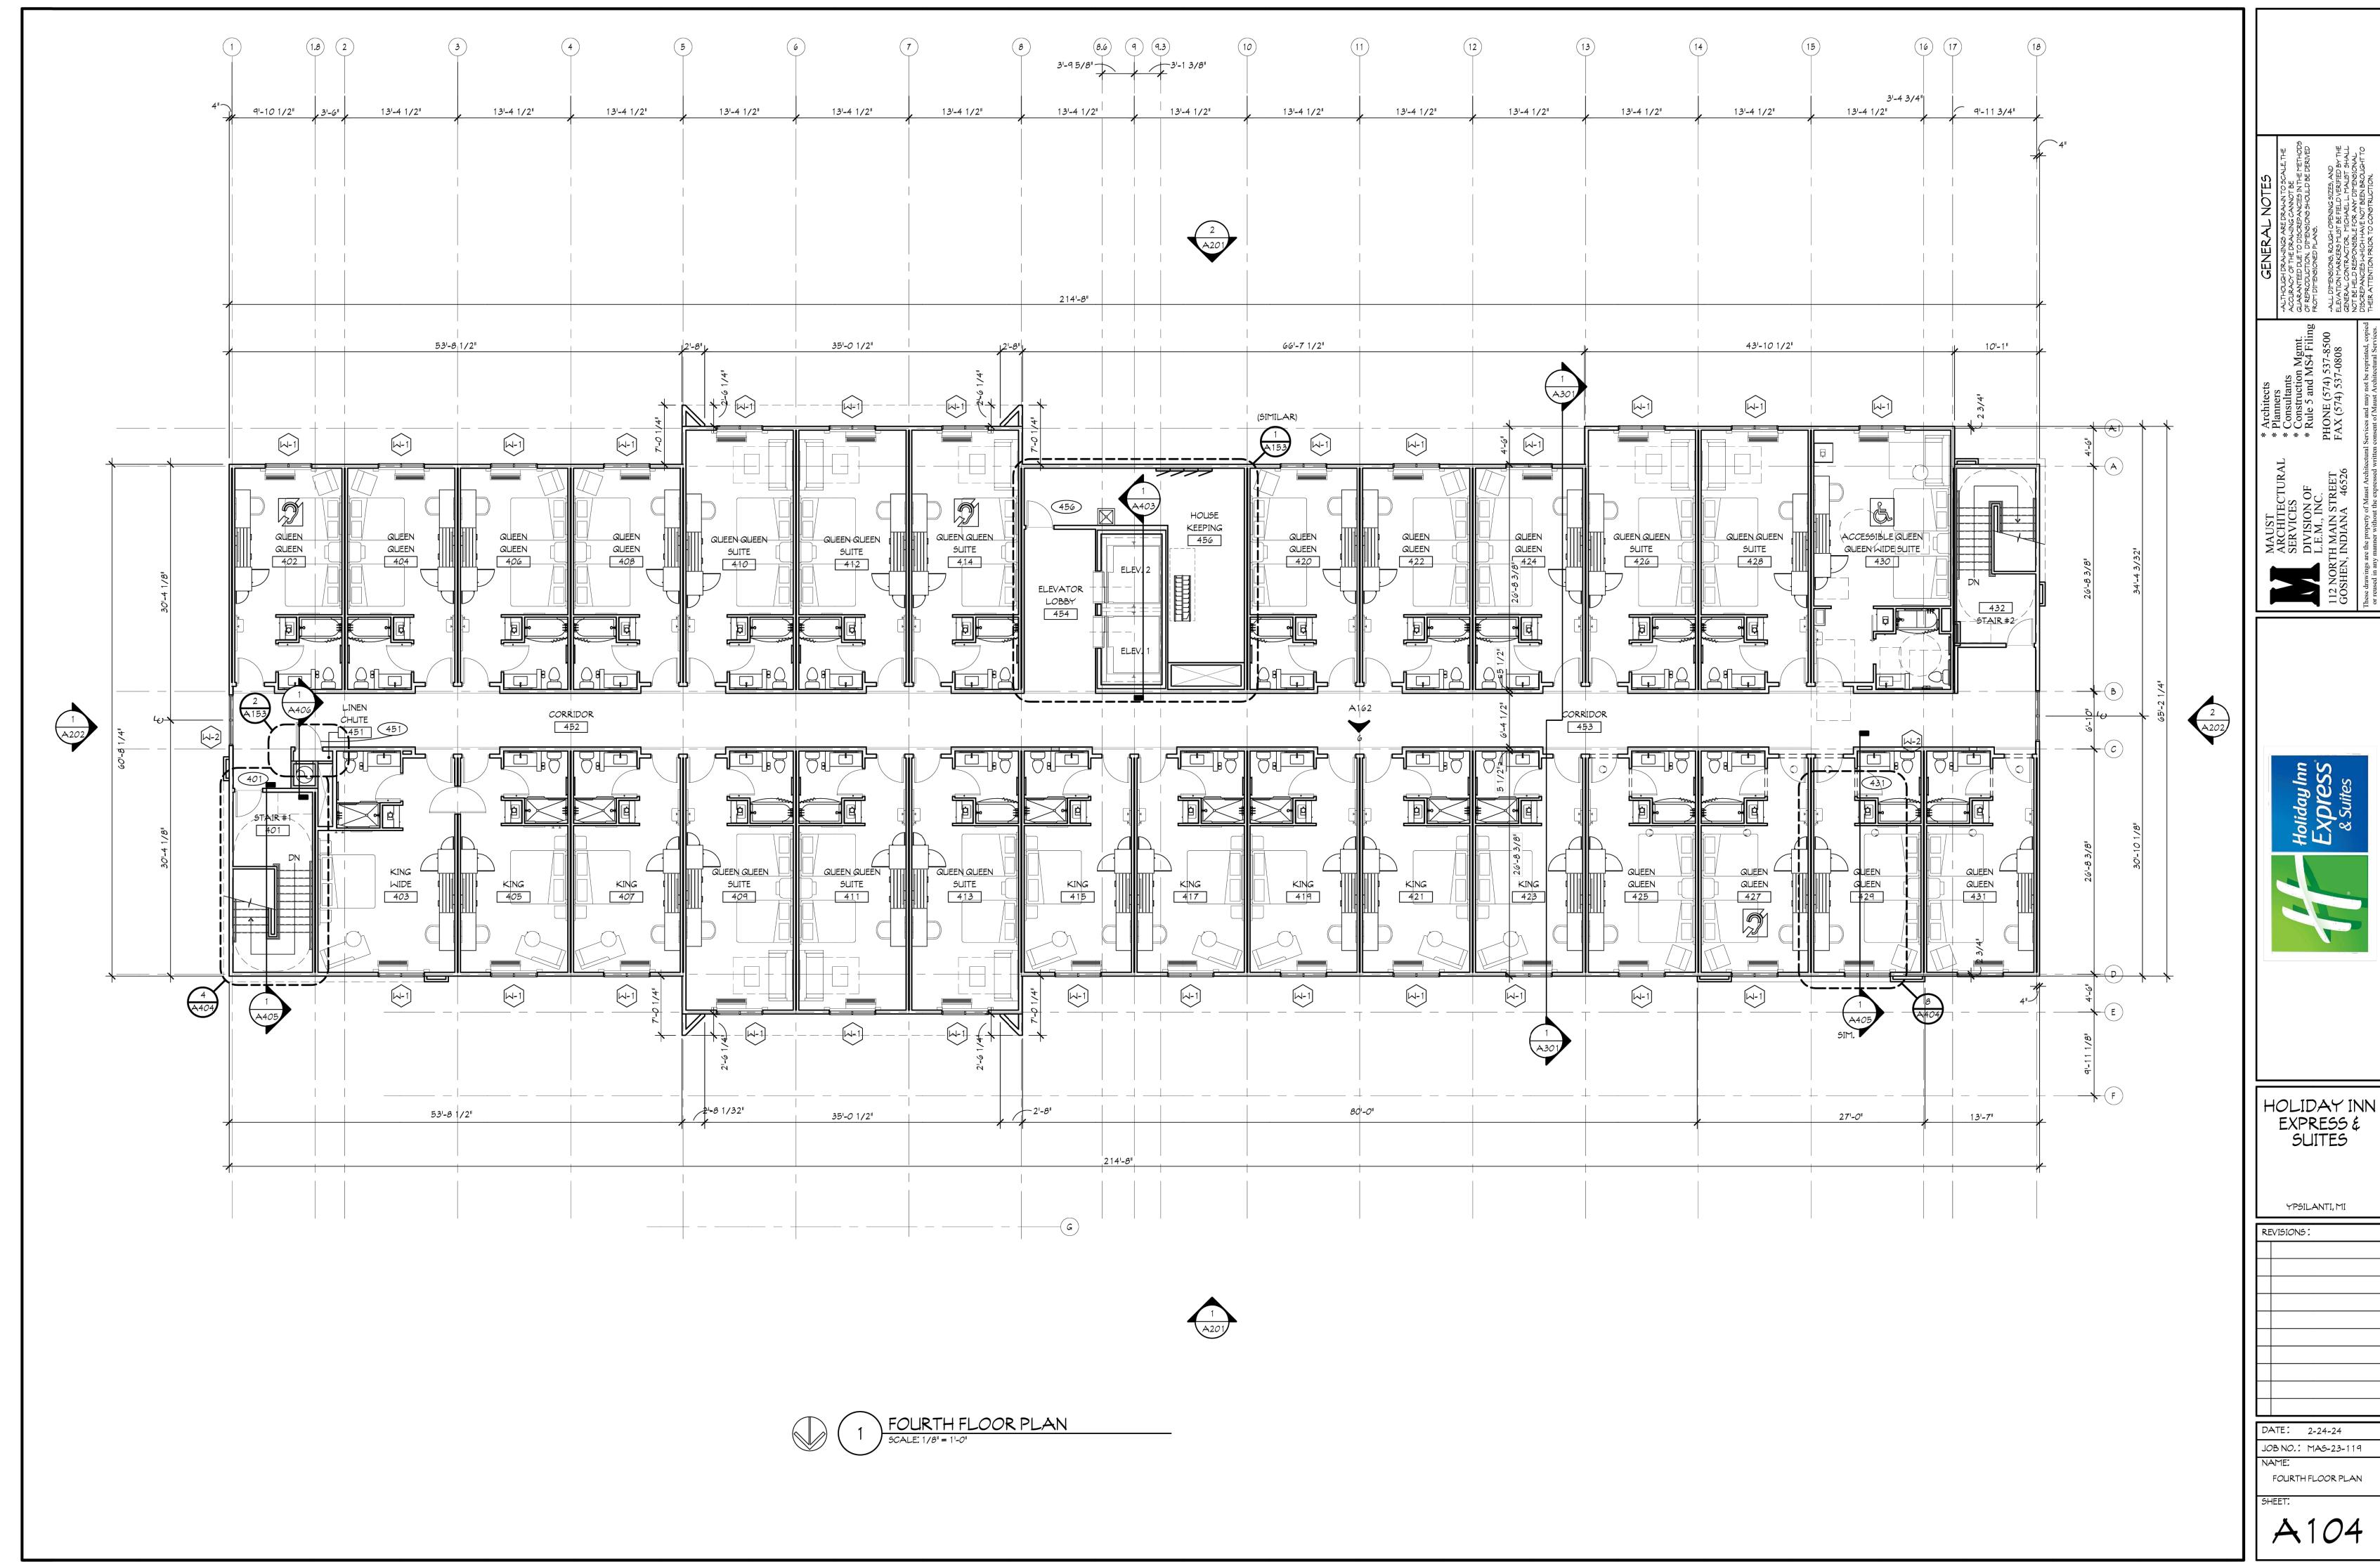


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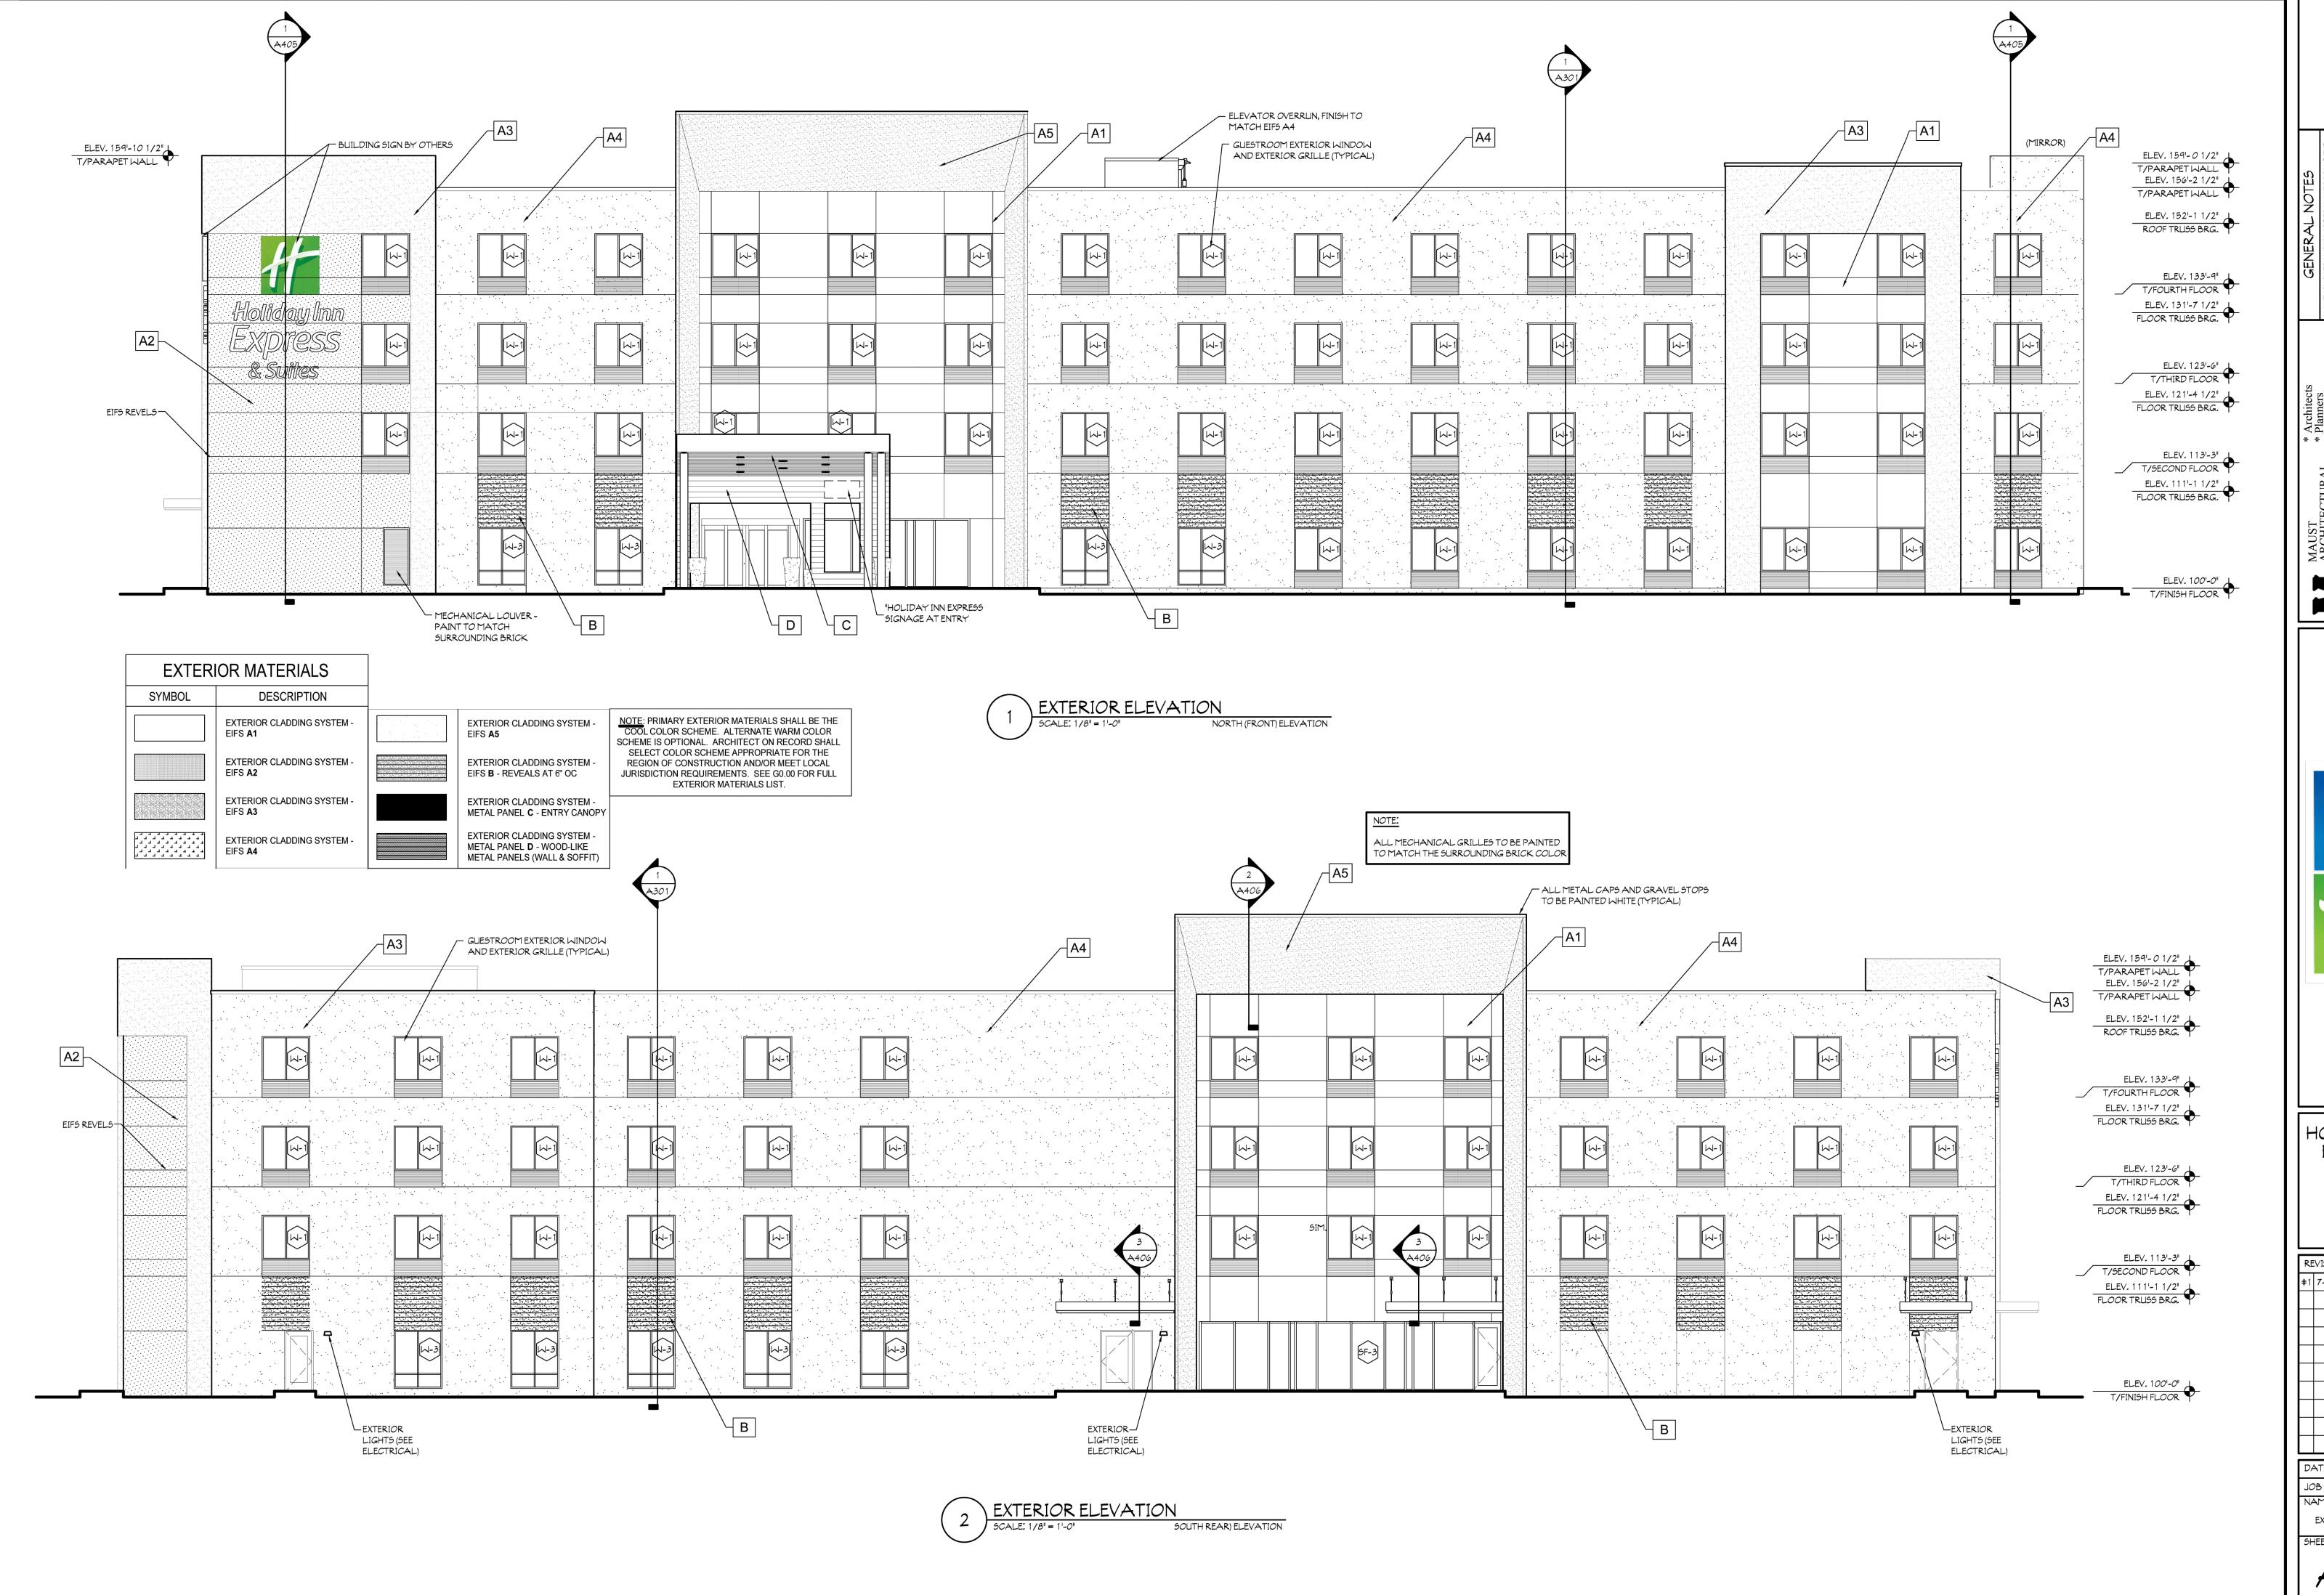
HOLIDAY INN EXPRESS & SUITES

JOB NO.: MAS-23-119





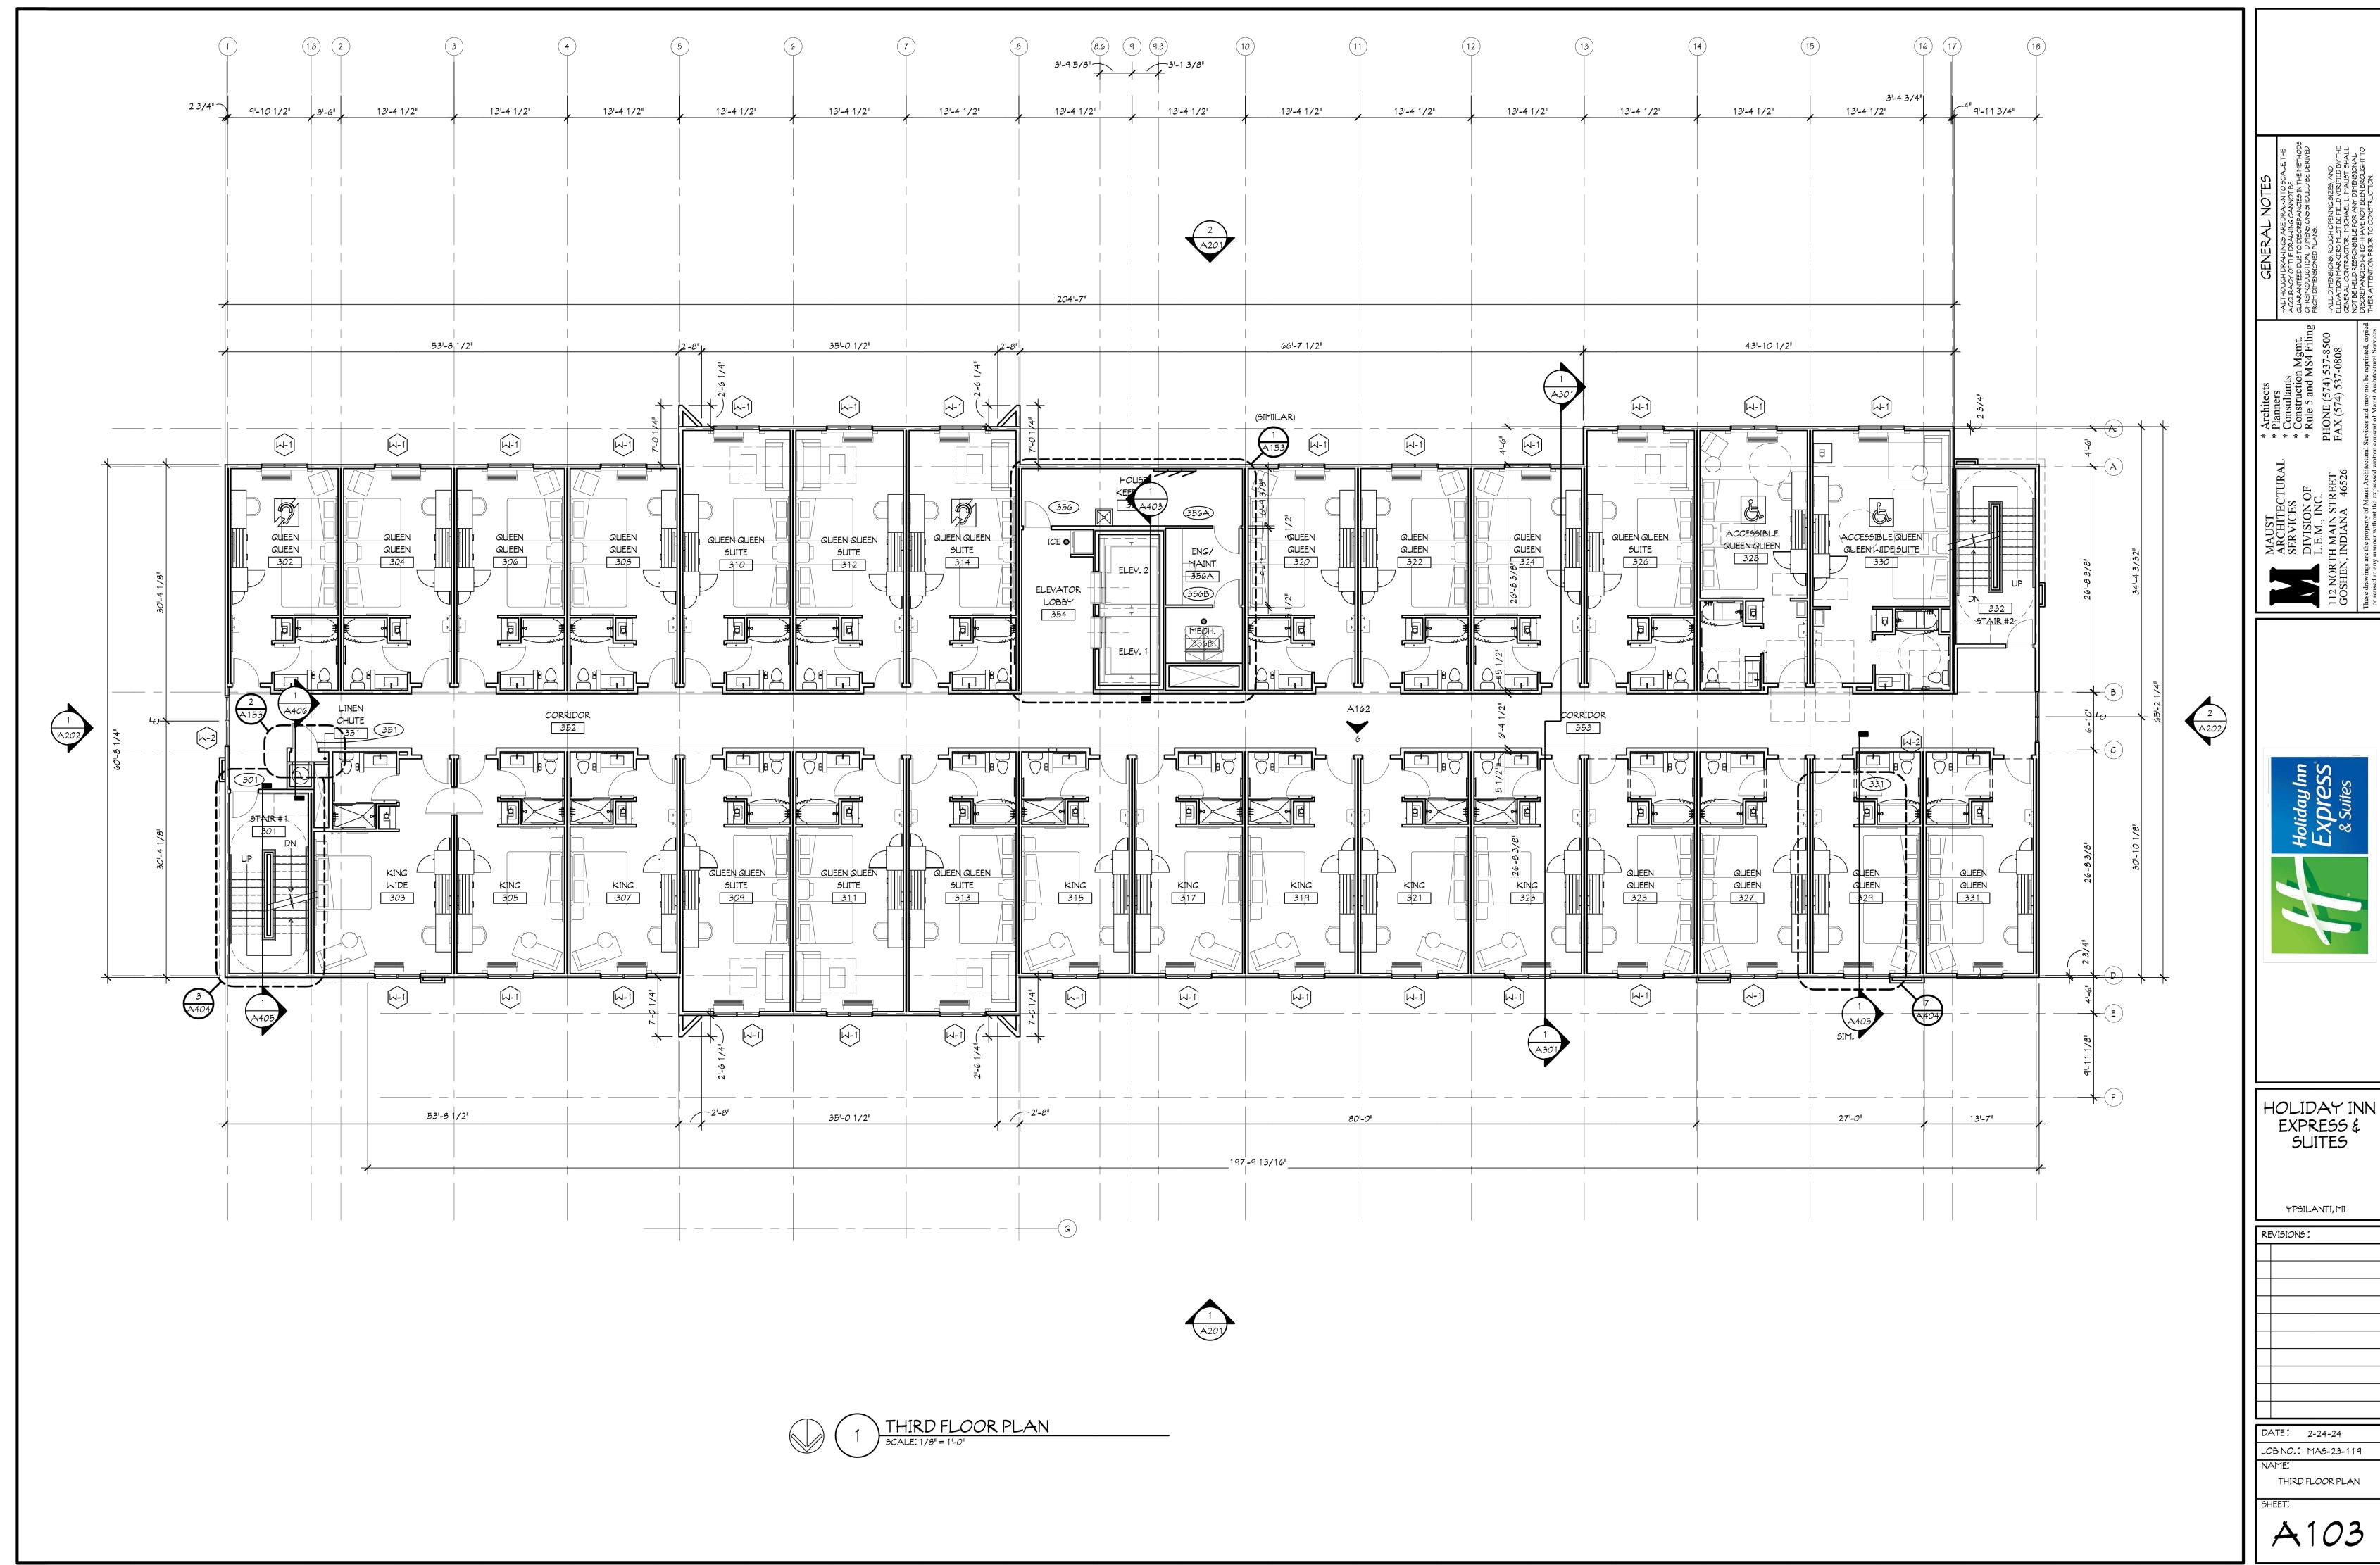



GENERAL NOTES

THOUGH DRALINGS ARE DRALIN TO SCALE, THE
CURACY OF THE DRALING CANNOT BE
ARANTEED DUE TO DISCREPANCIES IN THE METHODS
REPRODUCTION. DIFENSIONS SHOULD BE DERIVED
OM DIMENSIONED PLANS.

L. DIMENSIONE, ROUGH OPENING SIZES, AND
VATION MARKERS MUST BE FIELD VERIFIED BY THE
PREVENCE CONTRACTOR. MICHAEL L. MALIST SHALL

\* Architects
\* Planners
\* Consultants
\* Construction Mgmt.
\* Rule 5 and MS4 Filir
PHONE (574) 537-8500
FAX (574) 537-0808

SERVICES
DIVISION OF
L.E.M., INC.
112 NORTH MAIN STREET
GOSHEN, INDIANA 46526

Holiday Inn EXPress & Suites

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YPSILANTI, MI


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DATE: 2-24-24

JOB NO.: MA5-23-119
NAME:
EXTERIOR ELEVATIONS

EET:



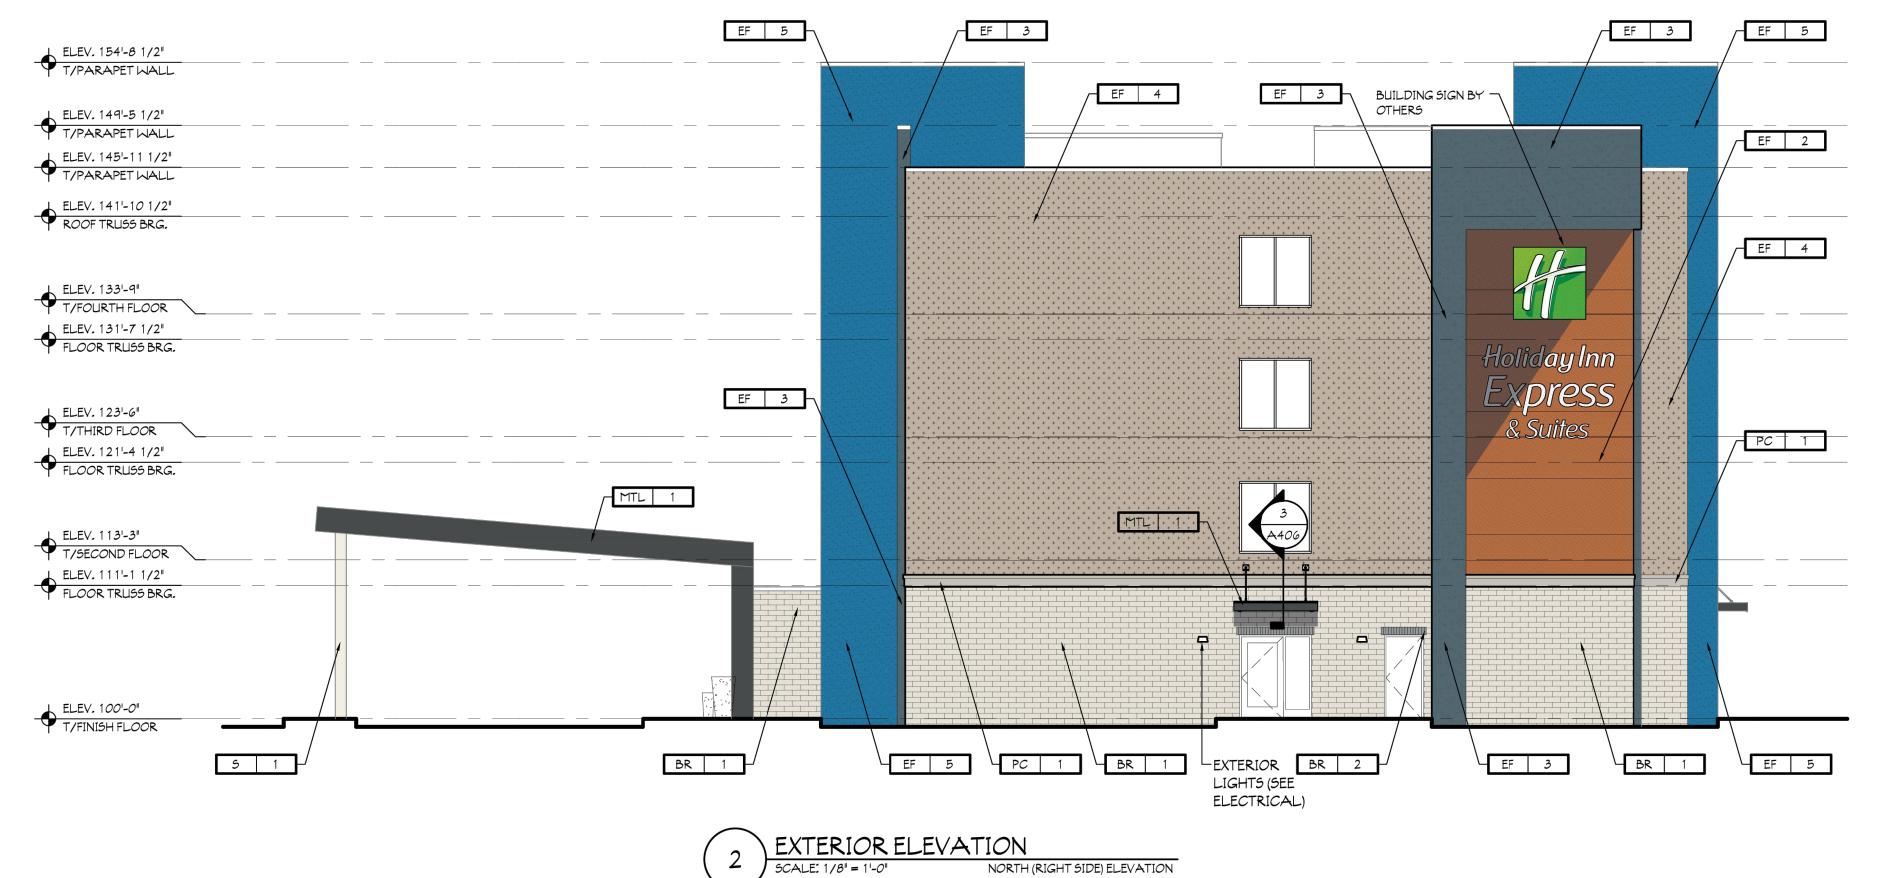

HOLIDAY INN EXPRESS & SUITES YPSILANTI, MI


DATE: 07-08-24

JOB NO.: MAS-23-119

EXTERIOR ELEVATIONS


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\* Architects
\* Planners
\* Consultants
\* Construction Mgmt.
\* Rule 5 and MS4 Filing
PHONE (574) 537-8500
FAX (574) 537-0808

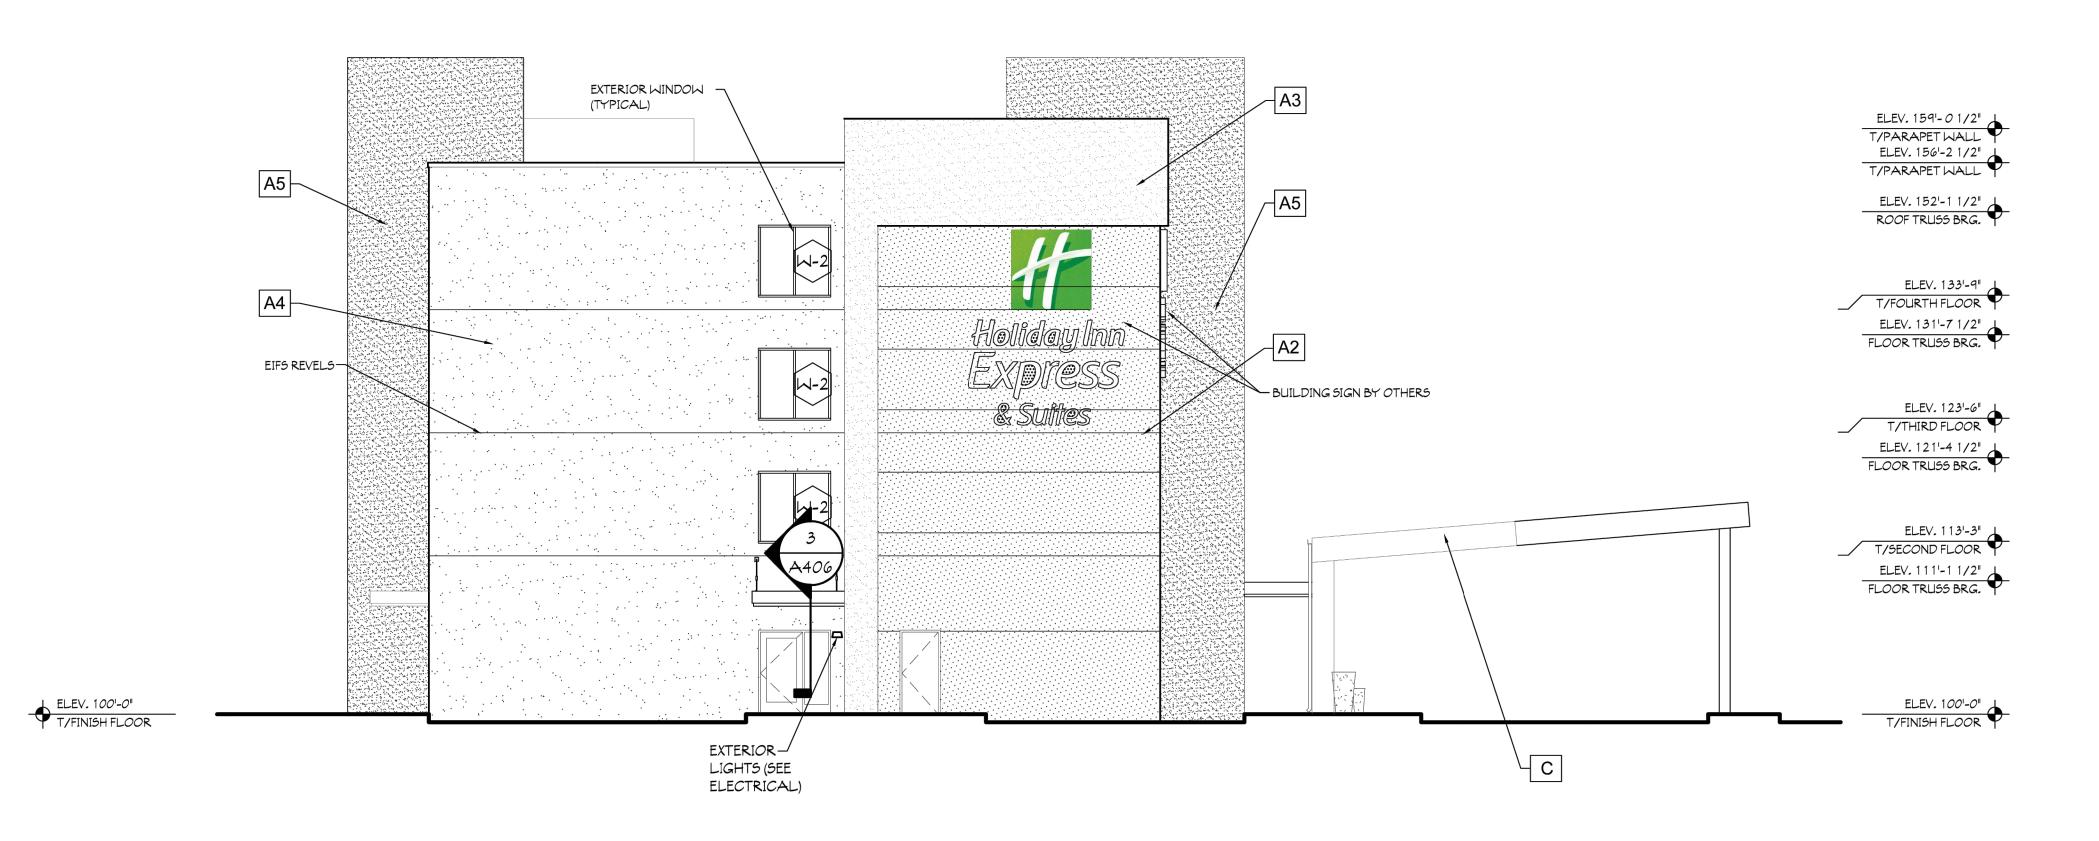

1 EXTERIOR ELEVATION

5CALE: 1/8" = 1'-0" (LEFT SIDE) ELEVATION

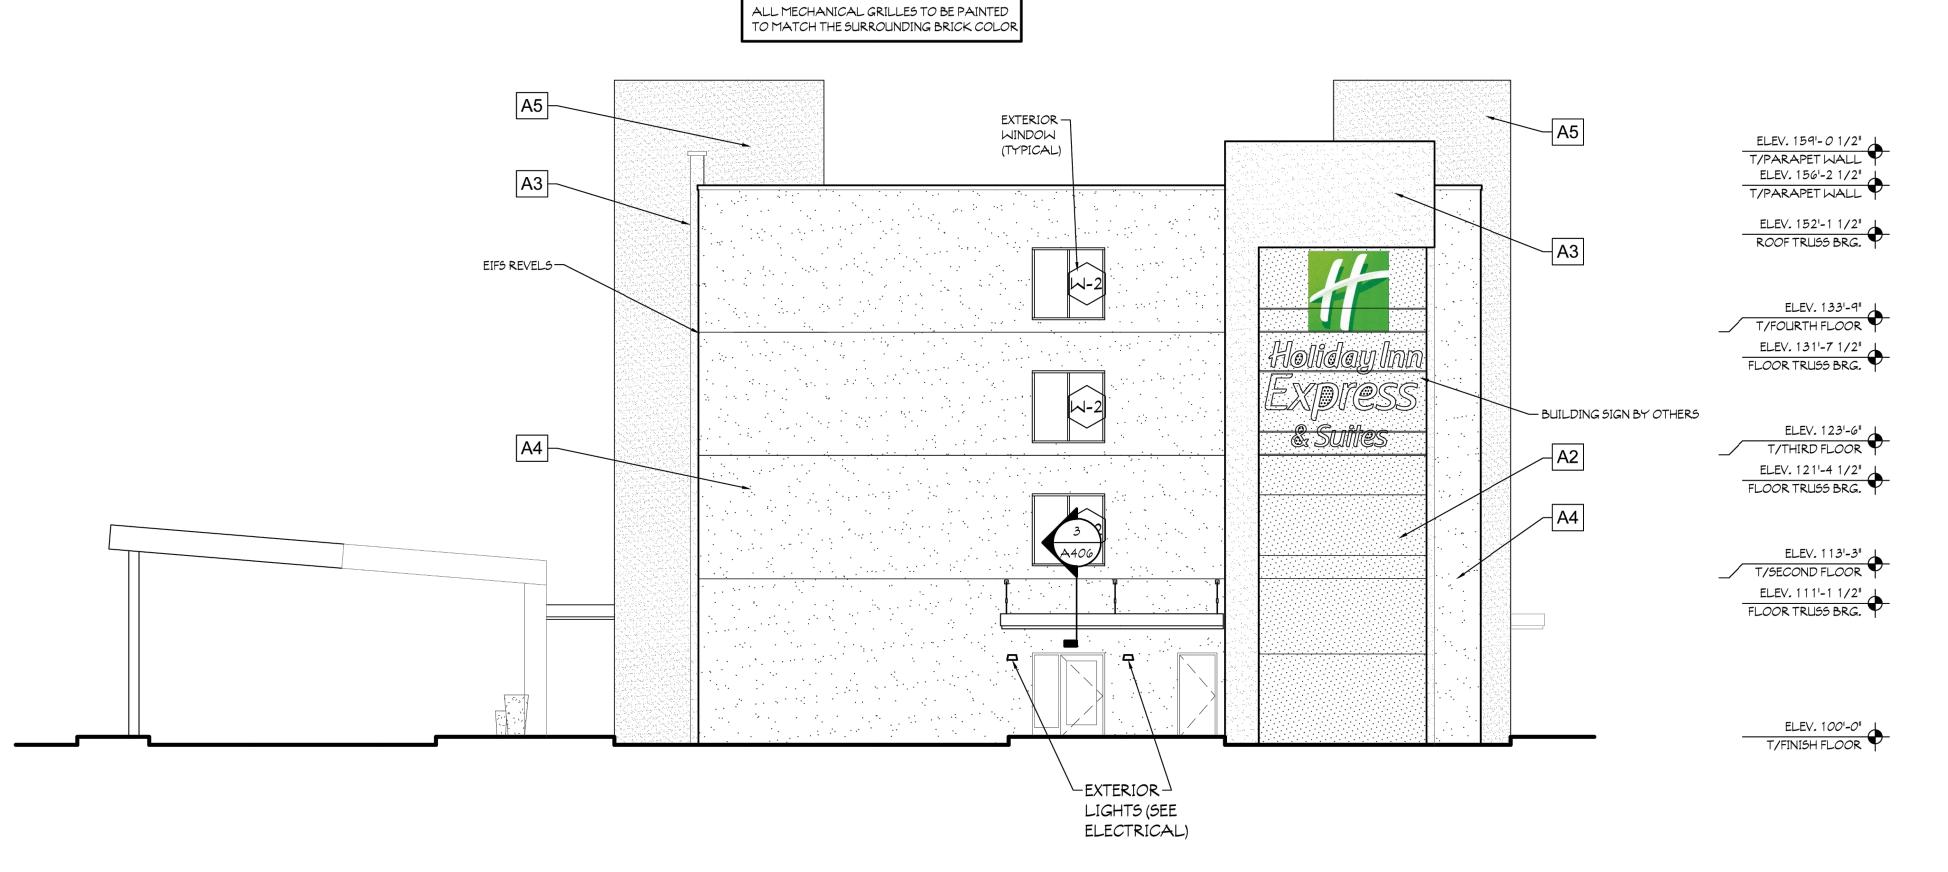

2 EXTERIOR ELEVATION

SCALE: 1/8" = 1'-0" (RIGHT SIDE) ELEVATION

EXTERIOR MATERIALS		
SYMBOL	DESCRIPTION	
	EXTERIOR CLADDING SYSTEM - EIFS <b>A1</b>	
	EXTERIOR CLADDING SYSTEM - EIFS <b>A2</b>	
	EXTERIOR CLADDING SYSTEM - EIFS <b>A3</b>	
	EXTERIOR CLADDING SYSTEM - EIFS <b>A4</b>	
	EXTERIOR CLADDING SYSTEM - EIFS <b>A5</b>	
	EXTERIOR CLADDING SYSTEM - EIFS <b>B</b> - REVEALS AT 6" OC	
	EXTERIOR CLADDING SYSTEM - METAL PANEL <b>C</b> - ENTRY CANOPY	
	EXTERIOR CLADDING SYSTEM - METAL PANEL <b>D</b> - WOOD-LIKE METAL PANELS (WALL & SOFFIT)	

SCHEME IS OPTIONAL. ARCHITECT ON RECORD SHALL SELECT COLOR SCHEME APPROPRIATE FOR THE

REGION OF CONSTRUCTION AND/OR MEET LOCAL
JURISDICTION REQUIREMENTS. SEE G0.00 FOR FULL
EXTERIOR MATERIALS LIST.

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CENERAL NOTES

-ALTHOUGH DRAWINGS ARE DRAWN TO SCALE, THE
ACCURACY OF THE DRAWING CANNOT BE
ACCURACY OF THE DRAWING CANNOT BE
ACCURACY OF THE DRAWING CANNOT BE
CUARANTEED DUE TO DISCREPANCIES IN THE METHODS
OF REPRODUCTION. DIMENSIONS SHOULD BE DERIVED
FROM DIMENSIONS, ROUGH OPENING SIZES, AND
ELEVATION MARKERS MUST BE FIELD VERIFIED BY THE
GENERAL CONTRACTOR. MICHAEL L. MAUST SHALL
NOT BE HELD RESPONSIBLE FOR ANY DIMENSIONAL

SERVICES

SERVICES

Constitution of the services and serv

Holiday Inn EXPress & Suites

HOLIDAY INN EXPRESS & SUITES

YPSILANTI, MI

REVISIONS:

DATE: 2-24-24

JOB NO.: MA5-23-119

NAME:

EXTERIOR ELEVATIONS
SHEET:

A202